


CALIFORNIA STATE LANDS COMMISSION

Carlsbad, California

8-25-11

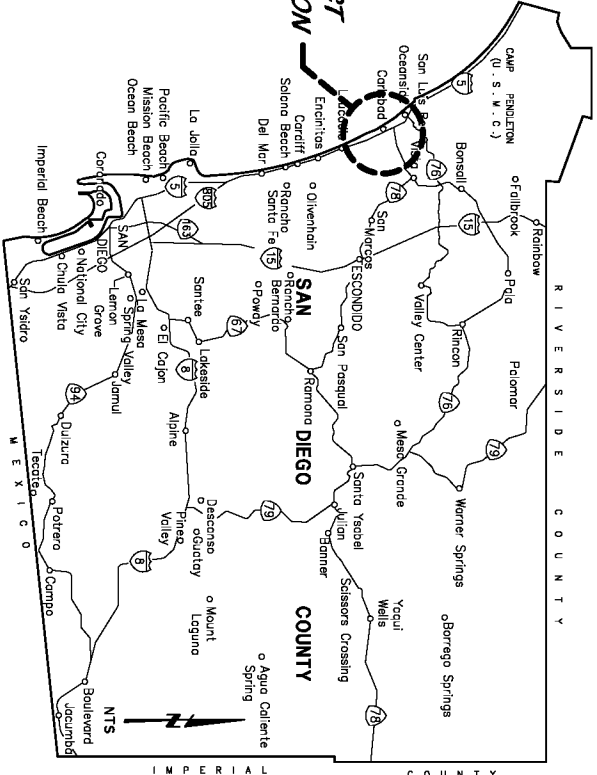

LOCATION MAP

NOT TO SCALE

PROJECT REFERENCE DOCUMENTS

1. MORFAT & NICHOL, ENGINEERS, 1994. BATTOUTS LAGOON ENHANCEMENT PROJECT. DESIGN PLANS 75 SHEET SET. PREPARED FOR CALIFORNIA DEPARTMENT OF FISH & GAME. (JANUARY 11, 1984)
2. KINNETIC LABORATORIES INCORPORATED. 2010. BATTOUTS LAGOON SEDIMENT SAMPLING PROJECT SUMMARY + APPENDICES. PREPARED FOR CALIFORNIA DEPARTMENT OF FISH & GAME. (MARCH 9, 2010)
3. CITY OF CARLSBAD DESALINATION BASIN AND STORM DRAIN DRAWINGS PREPARED BY CODY CONSULTANTS, APPROVED 10-12-94 (PROJECT NO. PE 2,94.08 AND CT 94-01, DRAWING NO. 337-9 AND 337-9A, SHEET 12 OF 24 AND SHEET 18 OF 38)



MERKEL & ASSOCIATES, Inc.
6434 RUFFIN ROAD
SAN DIEGO, CA 92123
PH. (658) 560-5465 FAX. (658) 560-7778



DIAL TOLL FREE
1-800-422-4133
AT LEAST TWO DAYS
BEFORE YOU DIG

UNDERGROUND SERVICE ALERT OF SOUTHERN CALIFORNIA

**IF DRAWING IS NOT FULL SIZE (24X36,
THEN REDUCE SCALE ACCORDINGLY**



ORIGINAL SCALE IN INCHES FOR REDUCED PLANS

SHEET INDEX


SHEET NO.	DWG	TITLE
1	C-1	PROJECT LOCATION AND VICINITY MAP
2	C-2	PROJECT NOTES
3	C-3	PROJECT NOTES
4	C-4	OVERALL SITE PLAN - STAGING & PHASING NOTES
5	C-5	SITE PLAN - EAST & CENTRAL BASINS
6	C-6	SITE PLAN - CENTRAL BASIN
7	C-7	SITE PLAN - WEST BASIN
8	C-8	SITE PLAN - BEACH NOURISHMENT
9	C-9	SITE PLAN - STORM DRAIN & REVENMENT RESTORATION
10	C-10	GROSS SECTIONS
11	C-11	GROSS SECTIONS
12	C-12	GROSS SECTIONS
13	C-13	GROSS SECTIONS
14	C-14	GROSS SECTIONS



TERRACOSTA CONSULTING GROUP, INC.
ENGINEERS & GEOLOGISTS
3880 MURPHY CANYON ROAD, SUITE 200
SAN DIEGO, CALIFORNIA 92123
(858) 573-6900

THE DRAWING INCORPORATED HEREIN HAVE BEEN PREPARED, IN PART, BASED UPON INFORMATION FURNISHED BY OTHERS. THE DESIGN PROFESSIONAL CANNOT ASSURE ITS ACCURACY AND, THEREFORE, IS NOT RESPONSIBLE FOR THE ACCURACY OF THESE DRAWINGS, OR FOR ANY ERRORS OR OMISSIONS WHICH MAY HAVE BEEN INCORPORATED INTO IT AS A RESULT. THOSE RELYING ON THESE DRAWINGS ARE ADVISED TO OBTAIN INDEPENDENT VERIFICATION OF ITS ACCURACY BEFORE APPLYING IT FOR ANY PURPOSE. IN ADDITION, DISCOVERY OF ANY DISCREPANCIES SHALL BE REPORTED WITHIN 24 HOURS OF DISCOVERY, (BEFORE OR AFTER CONTRACT AMEND) TO THE GOVERNING AGENCY, AND THE DESIGN ENGINEER FOR EVALUATION/REEXAMINATION OF AN APPROPRIATE COURSE OF ACTION BEFORE PROCEEDING WITH CONSTRUCTION. FAILURE TO DO SO WILL VOID APPLICATION FOR CHANGE CONDITIONS.

NOTE: CONTRACTOR IS ADVISED THAT THIS PROJECT INVOLVES WORK IN A FLUTUATING MARINE TIDAL ENVIRONMENT ON SOFT, MARINE SEDIMENT WITH AN UNSTABLE BASE. CONTRACTOR SHALL TAKE DUE PRECAUTIONS AND CARE IN ANTICIPATING PROBLEMS THAT MAY ARISE THEREFROM. ALL WORK SHALL BE IN CONFORMANCE WITH ALL REGULATORY AGENCY PERMITS, ENVIRONMENTAL CONDITIONS AND SPECIFICATIONS CONTAINED HEREIN.

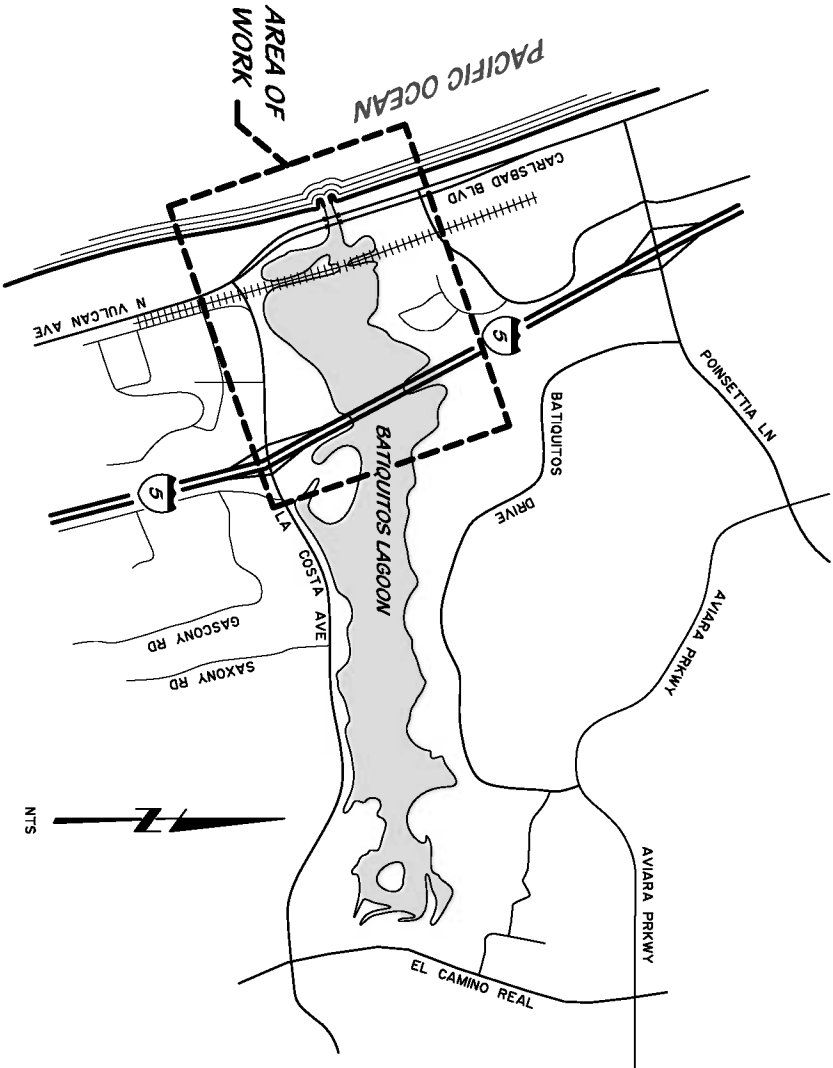

VICINITY MAP

NOT TO SCALE

CALIFORNIA STATE LANDS COMMISSION

DESIGNED	CARLSBAD, CALIFORNIA	DATE	8-25-11
KIM		SHEET	1 OF 14
DRAWN		CHECKED	
GS		REVIEW	
COVER		C-1	
BATAQUITOS LAGOON			
MAINTENANCE DREDGING 2011 - 2012			

ENVIRONMENTAL NOTES

- GENERAL
- THESE NOTES SHALL SUPPLEMENT CONDITIONS OF ENVIRONMENTAL PERMITS ISSUED FOR THE WORK. CONTRACTOR SHALL MAINTAIN A FULL SET OF ENVIRONMENTAL PERMITS ON THE PROJECT SITE AT ALL TIMES AND SHALL BE FAMILIAR WITH THE REQUIREMENTS APPLICABLE TO THE CONTRACTOR'S WORK.
 - IF CONFLICTS ARE FOUND TO EXIST BETWEEN ANY CONTRACT PROVISIONS, DRAWINGS, NOTES, SPECIFICATIONS, OR PERMITS, THE CONTRACTOR SHALL BRING THESE TO THE IMMEDIATE ATTENTION OF THE OWNER'S REPRESENTATIVE AND ENGINEER FOR DIRECTION ON HOW TO PROCEED.
 - STRINGENT COMPLIANCE WITH ENVIRONMENTAL CONDITIONS SHALL NOT RELIEVE CONTRACTOR FROM CONDUCTING WORK IN A PRUDENT AND ENVIRONMENTALLY PROTECTIVE MANNER.
 - THE CONTRACTOR SHALL IMPLEMENT MEASURES TO PREVENT VISIBLE DUST EMISSIONS FROM LEAVING THE PROJECT SITE BOUNDARY INCLUDING BUT NOT LIMITED TO WATERING PRIOR TO AND DURING ANY EARTH MOVEMENT, WATERING EXPOSED SOIL THREE TIMES PER DAY, INSTALLING WIND FENCING, COVERING EXCAVATED MATERIALS TO PREVENT EROSION, AND STOPPING WORK DURING HIGH WIND CONDITIONS. EFFECTIVE EROSION CONTROL SHALL ALSO BE IMPLEMENTED ON THE PROJECT SITE.
 - THE CONTRACTOR SHALL COVER ALL HAUL VEHICLES TO REDUCE FUGITIVE DUST GENERATED DURING THE TRANSPORT OF MATERIALS FROM THE SITE.
 - THE CONTRACTOR SHALL NOT ALLOW CONSTRUCTION EQUIPMENT AND VEHICLES TO TRACK DIRT AND DUST ONTO ROADWAYS, EQUIPMENT AND TIRES SHALL BE WASHED/SWEPT PRIOR TO LEAVING THE PROJECT SITE. CHATTER PLATES AND A STABILIZED CONSTRUCTION ENTRANCE SHALL BE PLACED NEAR POINTS OF EQUIPMENT INGRESSES/EGRESSES.
 - THE CONTRACTOR SHALL USE BEST MANAGEMENT PRACTICES TO FUEL AND MAINTAIN CONSTRUCTION EQUIPMENT AND CONSTRUCTION FACILITIES. ADDITIONALLY, ALL EQUIPMENT SHALL MEET APCD STANDARDS IN EFFECT AT THE TIME OF WORK.
 - DREDGING WITHIN THE LAGOON AND CHANNEL SHALL OCCUR DURING THE NON-NESTING SEASON BETWEEN AUGUST 31 AND MARCH 1.
 - THE FOLLOWING MEASURES SHALL BE TAKEN FOR ON-WATER WORK UNDER THIS CONTRACT.
A. CONTRACTOR ACCESS WITHIN THE WATERS OF BATIQUITOS LAGOON SHALL BE LIMITED TO THE EQUIPMENT NECESSARY TO EXCAVATE/DREDGE MATERIALS AND TRANSPORT/PUMP THEM TO THE DESIGNATED RECEIVING SITES.
B. A FIVE MILE PER HOUR BOATING SPEED LIMIT IN THE LAGOON SHALL BE ADHERED TO AT ALL TIMES.
C. CONTRACTOR SHALL MONITOR TIDES AND TIME VESSEL AND EQUIPMENT MOVEMENTS TO AVOID GROUNDINGS AND BOTTOM DISTURBANCE OUTSIDE OF WORK AREAS.
 - PRIOR TO CONSTRUCTION, THE CONTRACTOR SHALL PROVIDE INFORMATION TO THE USCG FOR THE NOTICE TO MARINERS, DESCRIBING THE LOCATION OF THE PIPE. CONTRACTOR SHALL ALSO POST NOTICES IN THE AREA OF WORK.

SENSITIVE SPECIES AND RESOURCES

- CONTRACTOR SHALL OPERATE WITHIN THE LIMITS OF WORK AND SHALL UTILIZE THE LEAST DAMAGING ROUTE FOR SITE ACCESS.
- PRIOR TO VACATING THE SITE, THE CONTRACTOR SHALL REPAIR ANY DAMAGE THAT HAS OCCURRED TO THE NESTING SITES AND SHALL ENSURE THAT A CLEAN CAP OF SAND AND/OR SHELL HASH IS IN PLACE ON THE SITES TO MATCH OR IMPROVE UPON PREPROJECT CONDITIONS.
- CONTRACTOR SHALL IMPLEMENT MEASURES TO PROTECT NATIVE WILDLIFE FROM INJURY DUE TO WORK PERFORMED. THESE INCLUDE KEEPING WORK WITHIN THE LIMITS OF CONSTRUCTION, IMPLEMENTING PROTECTION MEASURES, EXCLUDING DOMESTIC ANIMALS FROM SITE, CONTROLLING WASTE GENERATION AND DISPOSAL, AND REPAIRING ANY DAMAGE TO THE NESTING SITES PRIOR TO DEMOLIZING.

TIDAL DATUM AND BATHYMETRIC CONSTRAINTS

- THE CONTRACTOR IS ADVISED THAT BATIQUITOS LAGOON IS A SHALLOW ESTUARY AND WORK MAY BE TIDALLY CONSTRAINED AT VARIOUS TIMES DURING WORK.
- THE VERTICAL CONTROL AND BATHYMETRIC CONTOURS FOR THIS WORK ARE IN FEET MVD. TO EVALUATE TIDAL CONSTRAINTS USING STANDARD TIDE TABLES IN FEET MLLW, CONVERSIONS MUST BE APPLIED. CONVERSIONS FOR STANDARD TIDAL AMPLITUDE METRICS FOR OCEAN TIDES ARE SHOWN BELOW.

DATA	FEET, MVD 29	FEET, MLLW
MEAN LOWER LOW WATER	-2.6	0.0
MEAN SEA LEVEL	+0.6	+3.2
MEAN HIGHER HIGH WATER	+3.1	+5.7


- BATIQUITOS LAGOON IS A LIMITED TIDAL SYSTEM THAT RESULTS IN TIDAL TIME LAGS AND INCOMPLETE DRAINAGE. THIS TRUNCATING THE LOWER PORTION OF THE TIDAL CURVE AS THE SHOAL DREDGING IS PERFORMED. THE EXTENT OF LAG AND LOW TIDE DRAINAGE WILL INCREASE.
- CONTRACTOR IS ADVISED TO CONSIDER SHALLOW LAGOON BATHYMETRY WITHIN PROJECT WORK AREAS AND ALONG TRANSIT CORRIDORS AND TO PLAN DEEPER DRAFT EQUIPMENT MOVEMENTS ACCORDINGLY TO AVOID VESSEL GROUNDING.

ENVIRONMENTAL NOTES

- CONTRACTOR SHALL LIMIT THE USE OF STAGING AREAS TO EQUIPMENT NECESSARY TO PERFORM THE REQUIRED WORK.
- NO STAGING OR MATERIAL STORAGE SHALL OCCUR WITHIN PUBLIC PARKING AREAS OF THE LA COSTA PARK & RIDE.
- CONTRACTOR SHALL BE ALLOWED TO PUT CONTRACTOR LOCKS ON GFG GATES AND SHALL MAINTAIN GATES IN A CLOSED AND LOCKED CONDITION IN ORDER TO RESTRICT ACCESS TO THE ECOLOGICAL RESERVE.
- CONTRACTOR SHALL MAINTAIN THE SITE IN A CLEAN MANNER AND SHALL SECURE ALL TRASH, INCLUDING FOOD WASTES, IN CLOSED WASTE CONTAINERS.
- CONTRACTOR SHALL PROVIDE PORTABLE RESTROOM FACILITIES FOR ITS EMPLOYEES THAT SHALL BE SECURED AGAINST WINDS TO AVOID OVERTURNING IN THE WIND.
- UPON COMPLETION OF WORK, CONTRACTOR SHALL REMOVE ALL CONTRACTOR MATERIALS AND WASTES FROM THE SITE, INCLUDING PIPELINE CUTTING PLASTIC AND SHALL RESTORE ANY SITE DAMAGE.



MERKEL & ASSOCIATES, Inc.
6434 RUFFIN ROAD
SAN DIEGO, CA 92133
PH: (619) 560-9486 FAX: (619) 560-7778

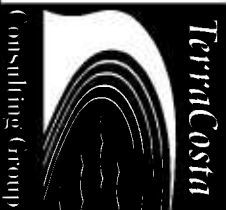

TERRACOSTA CONSULTING GROUP, INC.
ENGINEERS & GEOLOGISTS
3890 MURPHY CANYON ROAD, SUITE 200
SAN DIEGO, CALIFORNIA 92123
(619) 573-6900

IF DRAWING IS NOT FULL SIZE (24X36)
THEN REDUCE SCALE ACCORDINGLY

0 1 2 3

ORIGINAL SCALE IN INCHES FOR REDUCED PLANS

CALIFORNIA STATE LANDS COMMISSION



DIAL TOLL FREE
1-800-422-4133
AT LEAST TWO DAYS
BEFORE YOU DIG

UNDERGROUND SERVICE ALERT OF SOUTHERN CALIFORNIA

NOTE:
CONTRACTOR IS ADVISED THAT THIS PROJECT INVOLVES WORK IN A FLUCTUATING MARINE TIDAL ENVIRONMENT ON SOFT, MARINE SEDIMENT WITH AN UNSTABLE BASE. CONTRACTOR SHALL TAKE DUE PRECAUTIONS AND CARE IN ANTICIPATING PROBLEMS THAT MAY ARISE THEREFROM. ALL WORK SHALL BE IN CONFORMANCE WITH ALL REGULATORY AGENCY PERMITS, ENVIRONMENTAL CONDITIONS AND SPECIFICATIONS CONTAINED HEREIN.

THE DRAWINGS INCORPORATED HEREIN HAVE BEEN PREPARED, IN PART, BASED UPON INFORMATION FURNISHED BY OTHERS. THE DESIGN PROFESSIONAL CANNOT ASSURE ITS ACCURACY AND, THUS, IS NOT RESPONSIBLE FOR THE ACCURACY OF THESE INFORMATION. CONTRACTOR SHALL BE RESPONSIBLE FOR OBTAINING ALL NECESSARY RECORDS, AND ANY ERRORS OR OMISSIONS BELONGING TO THESE RECORDS ARE ADVISED TO OBTAIN INDEPENDENT VERIFICATION OF ITS ACCURACY BEFORE APPLYING IT FOR ANY PURPOSE. IN ADDITION, DISCOVERY OF ANY DISCREPANCIES SHALL BE REPORTED WITHIN 24 HOURS OF DISCOVERY (BEFORE OR AFTER CONTRACT AWARD) TO THE GOVERNING AGENCY AND THE DESIGN ENGINEER FOR EVALUATION/DETERMINATION OF AN APPROPRIATE COURSE OF ACTION BEFORE PROCEEDING WITH CONSTRUCTION. FAILURE TO DO SO, WILL VOID APPLICATION FOR CHANGE CONDITIONS.

DESIGNED	KL	BATIQUITOS LAGOON MAINTENANCE DREDGING 2011 - 2012	DATE 8-27-11	
DRAWN	GS			SHEET 3 of 14
CHECKED	WFC			
PROJECT NOTES		REV.		



MERKEL & ASSOCIATES, Inc.
5434 RUFFIN ROAD
SAN DIEGO, CA 92123
PH. (858) 560-5465 FAX. (858) 560-7779



**DIAL TOLL FREE
1-800-422-4133
AT LEAST TWO DAYS
BEFORE YOU DIG**

UNDERGROUND SERVICE ALERT OF SOUTHERN CALIFORNIA

**IF DRAWING IS NOT FULL SIZE (24X36)
THEN REDUCE SCALE ACCORDINGLY**

ORIGINAL SCALE IN INCHES FOR REDUCED PLANS

CALIFORNIA STATE LANDS COMMISSION



TERRACOSTA CONSULTING GROUP, INC.
ENGINEERS & GEOLOGISTS
3890 MURPHY CANYON ROAD, SUITE 200
SAN DIEGO, CALIFORNIA 92123
(858) 573-6900

CARLSBAD, CALIFORNIA

BATIQUITOS LAGOON

MAINTENANCE DREDGING 2011 - 2012

OVERALL SITE PLAN - STAGING & PHASING NOTES

HORIZ. CT. SP20, NAD 83	DATE	8-25-11
VERT. CT. SP20, NAD 83	SHEET	4 OF 14
DRAWING NO.	C-4	REV.




MAJOR ELEMENTS OF WORK

1. CONTRACTOR SHALL USE THE E-1 NESTING SITE FOR BREEDING STAGING, REFUELING & LAYDOWN AREA SHOWN ON DRAWING C-5.
2. DREDGE CENTRAL BASIN TO THE LINES AND GRADES INDICATED ON THESE DRAWINGS STARTING WITH SECTION CB-1-CB-2, CB-3, AND CB-4, SHOWN ON DRAWING C-6.
3. PUMP DREDGED MATERIAL FROM CENTRAL BASIN TO THE BEACH RENOURISHMENT AREA IDENTIFIED ON DRAWING C-8.
4. PERFORM EROSION MAINTENANCE OF WEST BASIN SHOWN ON DRAWING C-7 AND C-9. EXCAVATE AND REGRADE AREAS AS NECESSARY.
5. REPAIR/ENHANCE ROCK REVETMENT AROUND EXISTING STORM DRAIN OUTFALL IN WEST BASIN SHOWN ON DRAWING C-9.
6. GROOM BEACH AND INSTALL SAND DUNE FENCING SHOWN ON DRAWING C-8.
7. INSTALL DRIVABLE GRASS SWALE SHOWN ON DRAWING C-7
8. INSTALL NEW VINYL COATED CHAIN LINK FENCING SHOWN ON DRAWING C-7 & C-9.
9. INSTALL NEW VINYL COATED GATE SHOWN ON DRAWING C-7
10. RESTORE ALL CONTRACTOR DISTURBED AREAS TO THE PRECONSTRUCTION CONDITION.
11. ADDITIONALLY REQUIRED ITEMS MAY NOT BE REFLECTED IN THIS LIST.

NOTE:

CONTRACTOR IS ADVISED THAT THIS PROJECT INVOLVES WORK IN A FLUCTUATING MARINE TIDAL ENVIRONMENT ON SOFT, MARINE SEDIMENT WITH AN UNSTABLE BASE. CONTRACTOR SHALL TAKE DUE PRECAUTIONS AND CARE IN ANTICIPATING PROBLEMS THAT MAY ARISE THEREFROM. A WORK SHALL BE IN CONFORMANCE WITH ALL REGULATOR AGENCY PERMITS, ENVIRONMENTAL CONDITIONS AND SPECIFICATIONS CONTAINED HEREIN.

THE DRAWINGS INCORPORATED HEREIN HAVE BEEN PREPARED, IN PART, BASED UPON INFORMATION FURNISHED BY OTHERS. THE DESIGN PROFESSIONAL CANNOT ASSURE ITS ACCURACY AND, THEREFORE, IS NOT RESPONSIBLE FOR THE ACCURACY OF THESE DRAWINGS, OR FOR ANY ERRORS OR OMISSIONS WHICH MAY HAVE BEEN INCORPORATED INTO IT AS A RESULT. THOSE RELYING ON THESE DRAWINGS ARE ADVISED TO OBTAIN INDEPENDENT VERIFICATION OF ITS ACCURACY BEFORE APPLYING IT FOR ANY PURPOSE. IN ADDITION, DISCOVERY OF ANY DISCREPANCIES SHALL BE REPORTED WITHIN 24 HOURS OF DISCOVERY, BEFORE OR AFTER CONTRACT AWARD TO THE GOVERNING AGENCY AND THE DESIGN ENGINEER FOR EVALUATION/DETERMINATION OF AN APPROPRIATE COURSE OF ACTION BEFORE PROCEEDING WITH CONSTRUCTION. FAILURE TO DO SO, WILL, VOID APPLICATION FOR CHANGE CONDITIONS.

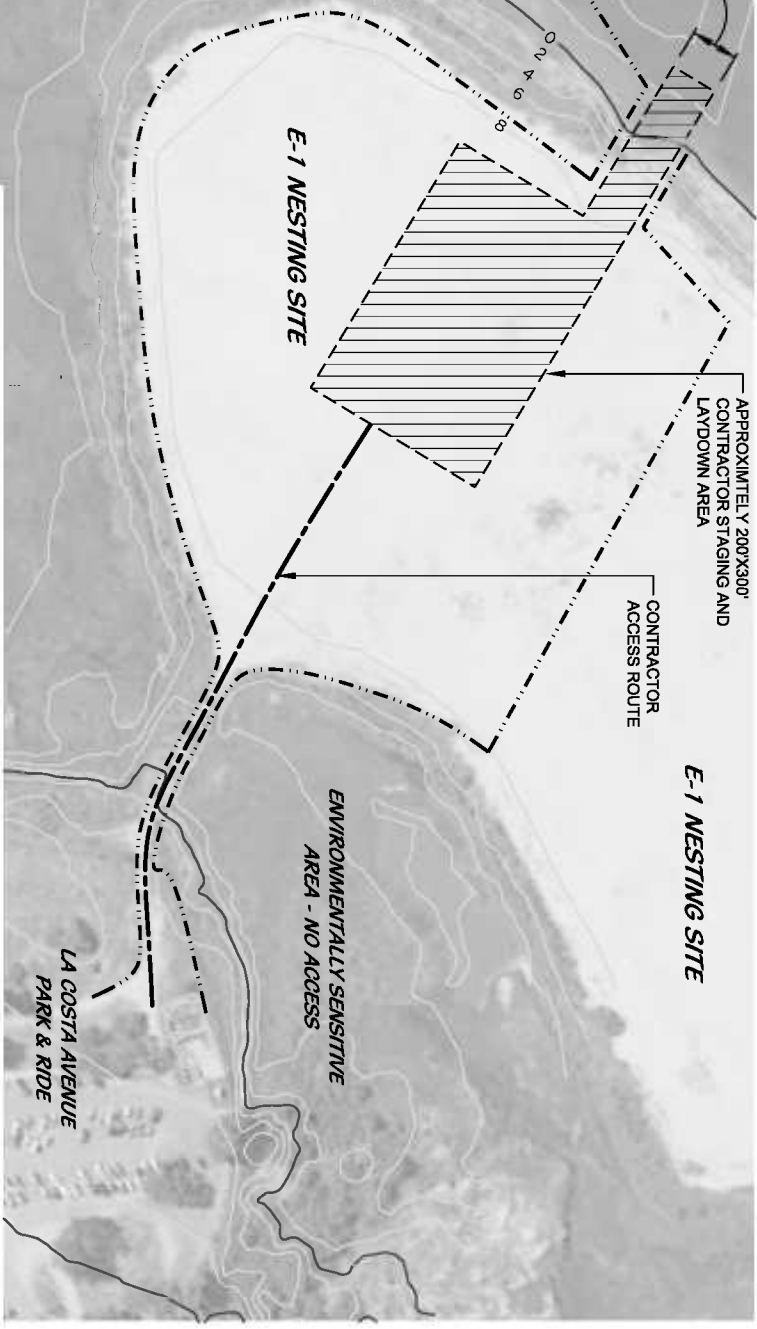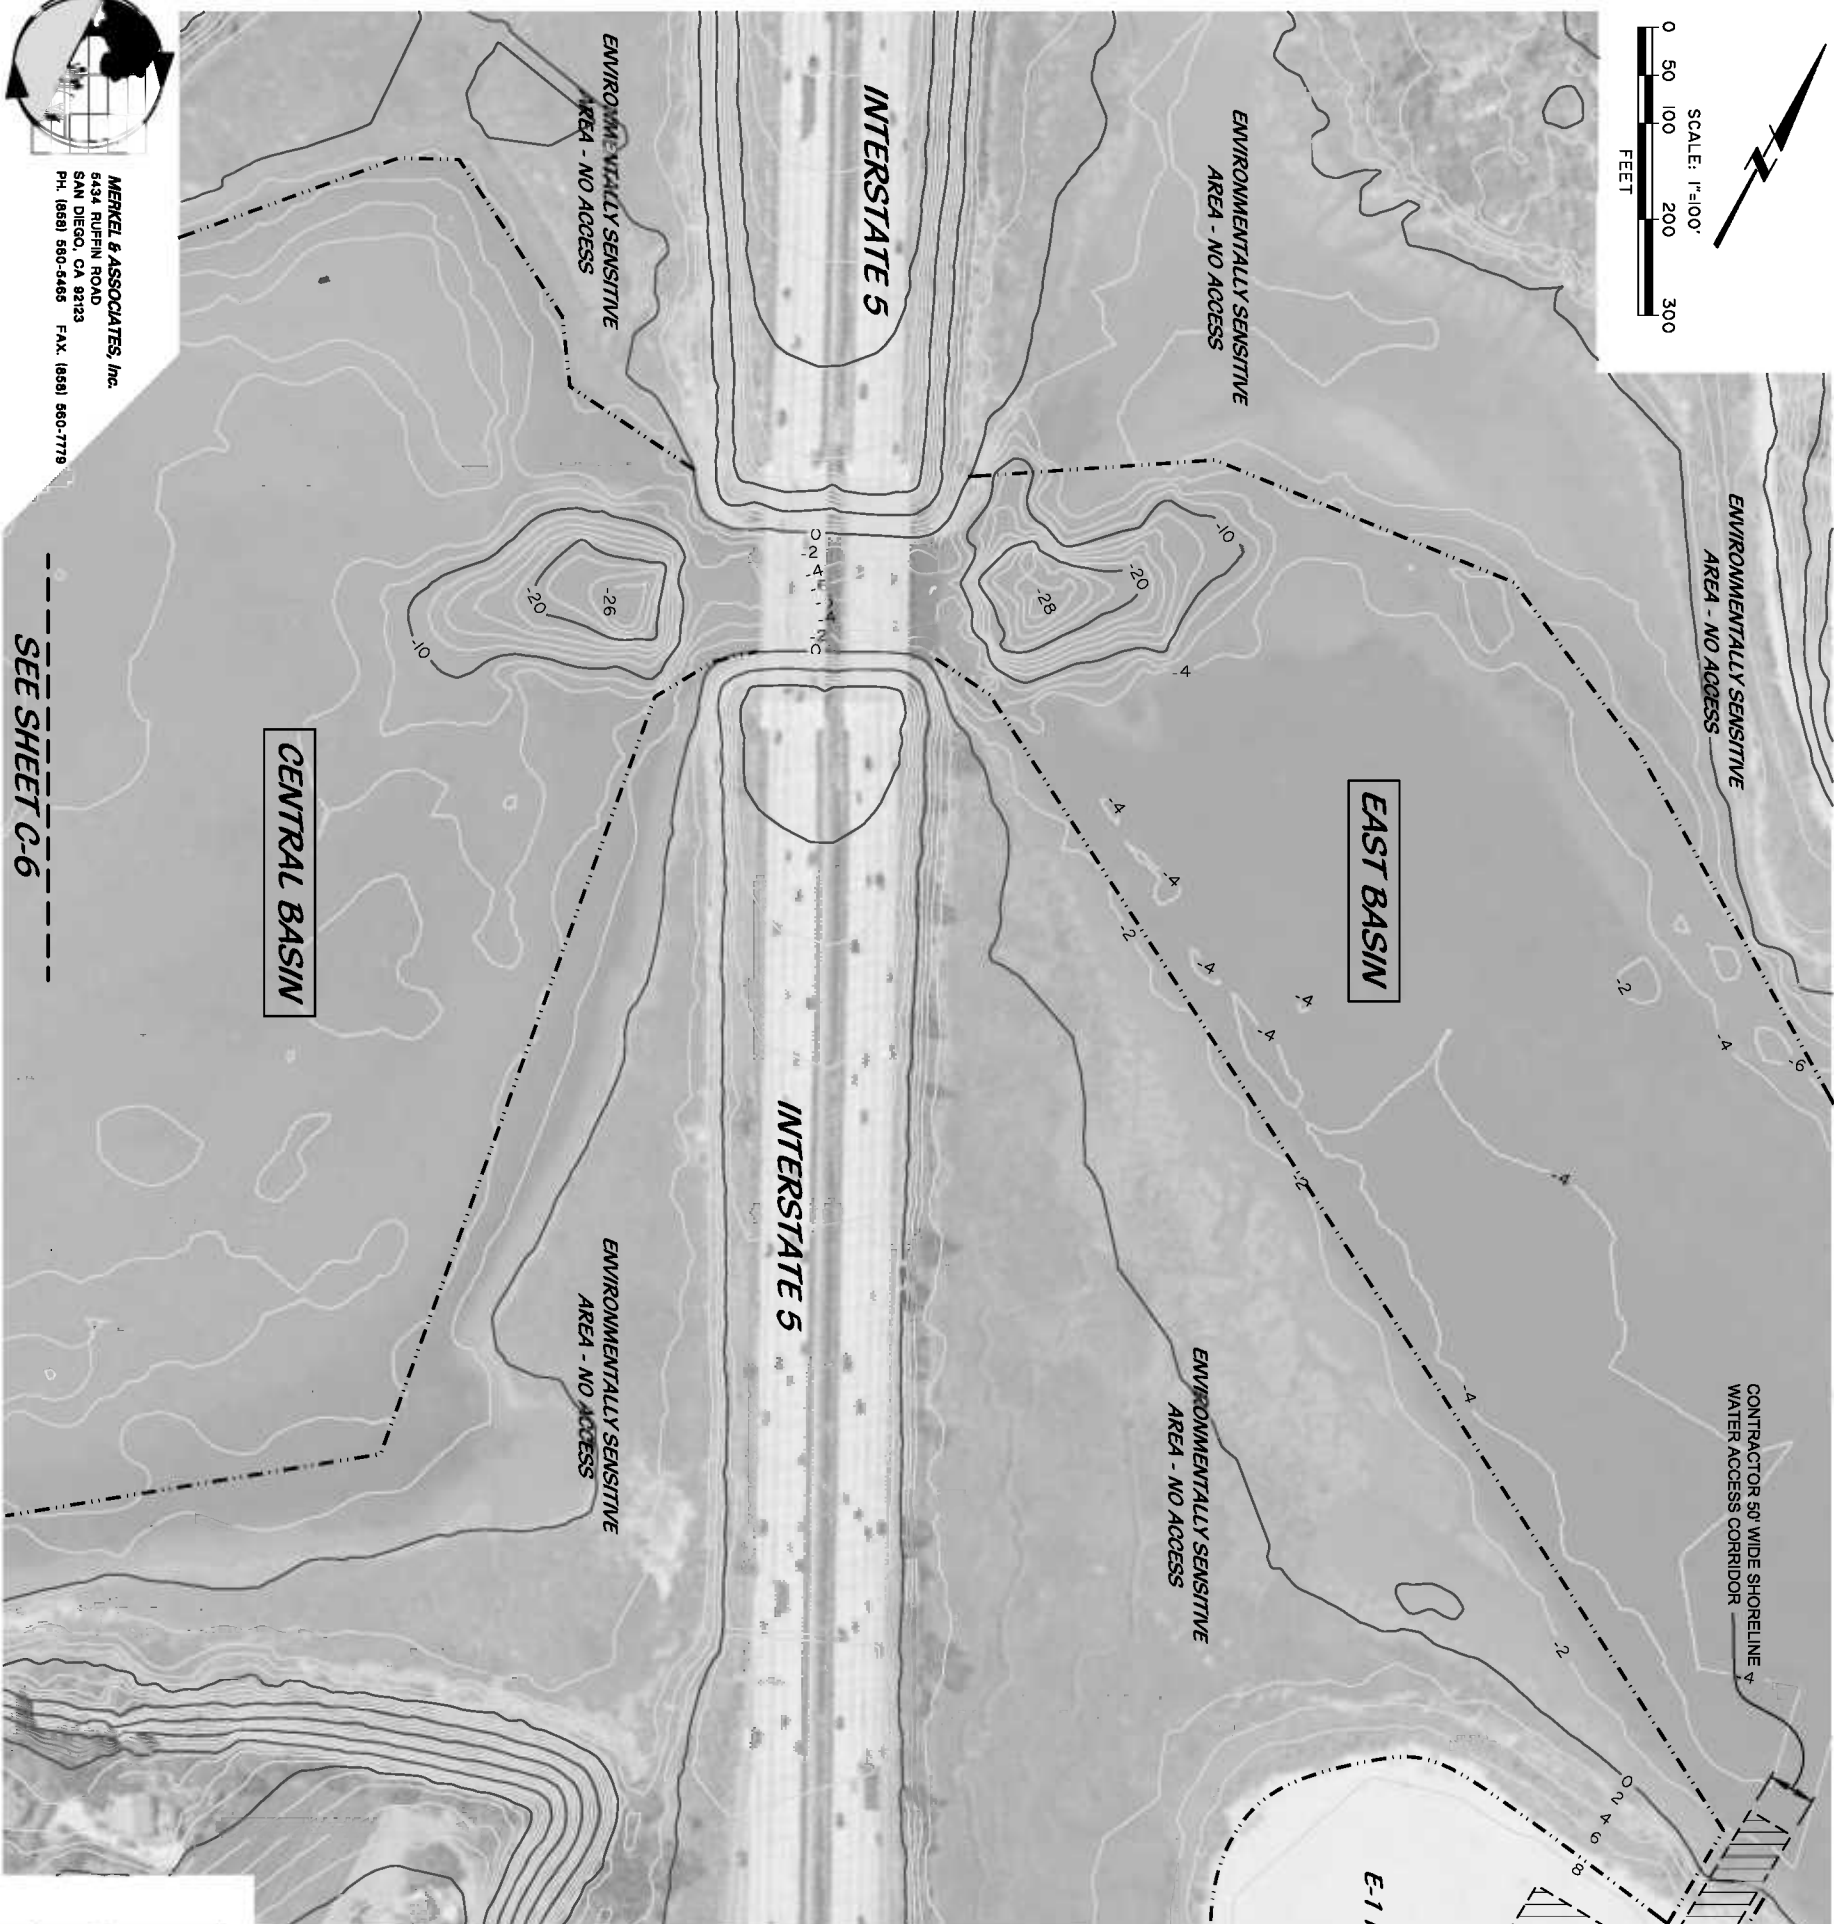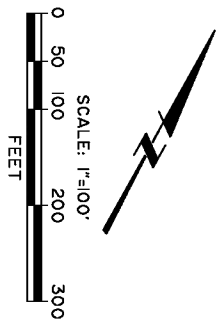

FUEL STORAGE PLAN

1. CONTRACTOR SHALL STORE NO MORE THAN 150 GAL. OF FUEL AND LUBRICANTS ON THE STAGING AREA AT ANY GIVEN TIME.
2. FUEL SHALL BE STORED WITHIN A SINGLE WALLED TANK PROVIDING SECONDARY CONTAINMENT, OR AN INTEGRATED SECONDARY CONTAINMENT TANK.
3. LUBRICANTS SHALL BE STORED WITHIN A SECONDARY CONTAINMENT SYSTEM.
4. DREDGE HYDRAULIC FLUIDS SHALL BE LIMITED TO A VEGETABLE OIL BASED BIODEGRADABLE OIL.
5. CONTRACTOR SHALL MAINTAIN READILY AVAILABLE OIL ABSORBENT PADS AND RECOVERY MATERIALS AT THE STAGING AREA AND ON FUEL, TRANSPORT VESSELS AND THE DREDGE.
6. DURING FUEL TRANSFERS, CONTRACTOR SHALL PLACE ABSORBENT PADS AT FUELING POINTS AND SHALL CAPTURE, REMOVE, AND PROPERLY DISPOSE OF ANY SPILLED FUELS AND CLEAN UP MATERIALS.
7. THE CONTRACTOR SHALL IMMEDIATELY NOTIFY THE OWNERS REPRESENTATIVE AND THE CDFG ECOLOGICAL RESERVE MANAGER, IN ADDITION TO THE LEGALLY REQUIRED FEDERAL, STATE, AND LOCAL REPORTING CHANNELS (INCLUDING THE NATIONAL RESPONSE CENTER, 1-800-424-8802) IF A REPORTABLE QUANTITY OF OIL OR FUEL IS RELEASED TO THE ENVIRONMENT.
8. CONTRACTOR SHALL CONDUCT ALL REFUELING ACTIVITIES IN A WELL-LIGHTED CONDITION WITH QUALIFIED PERSONNEL ONLY. REFUELING SHALL BE PERFORMED AT ALL TIMES RATHER THAN RELYING ON AUTOMATIC SHUTOFF EQUIPMENT.

ADD'L STAGING & ACCESS NOTES

1. SEE NOTES SHEET C-3 REGARDING STAGING AREA USE REQUIREMENTS.
2. CONTRACTOR SHALL SECURE AND LOCK ECOLOGICAL RESERVE/GATES WHEN NOT IN USE.
3. CONTRACTOR IS ADVISED OF SHALLOW CONDITIONS THAT MAY RESTRICT PERIODS OF ACCESS BETWEEN THE STAGING AREA AND DEPDEE SITE BY ALL BUT SHALLOW DRAFT VESSELS DURING LOW TIDE.

UNDERGROUND SERVICE ALERT OF SOUTHERN CALIFORNIA



DIAL TOLL FREE
1-800-422-4133
AT LEAST TWO DAYS
BEFORE YOU DIG

NOTE:

CONTRACTOR IS ADVISED THAT THIS PROJECT INVOLVES WORK IN A FLUCTUATING MARINE TIDAL ENVIRONMENT OF SOFT, MARINE SEDIMENT WITH AN UNSTABLE BASE. CONTRACTOR SHALL TAKE DUE PRECAUTIONS AND CARE IN ANTICIPATING PROBLEMS THAT MAY ARISE THEREFROM. WORK SHALL BE IN CONFORMANCE WITH ALL REGULATORY AGENCY PERMITS, ENVIRONMENTAL CONDITIONS AND SPECIFICATIONS CONTAINED HEREIN.

THE DRAWING INCORPORATED HEREIN HAVE BEEN PREPARED, IN PART, BASED UPON INFORMATION FURNISHED BY OTHERS. THE DESIGN PROFESSIONAL CANNOT ASSURE ITS ACCURACY AND, THERE, IS NOT RESPONSIBLE FOR THE ACCURACY OF THESE DRAWINGS, OR FOR ANY ERRORS OR OMISSIONS WHICH MAY HAVE BEEN INCORPORATED INTO IT AS A RESULT. THOSE RELYING ON THESE DRAWINGS ARE ADVISED TO OBTAIN INDEPENDENT VERIFICATION OF ITS ACCURACY BEFORE APPLYING IT FOR ANY PURPOSE. IN ADDITION, DISCOVERY OF ANY DISCREPANCIES SHALL BE REPORTED WITHIN 24 HOURS OF DISCOVERY, (BEFORE OR AFTER CONTRACT AWARD) TO THE GOVERNING AGENCY, AND THE DESIGN ENGINEER FOR EVALUATION/TERMINATION OF AN APPROPRIATE COURSE OF ACTION BEFORE PROCEEDING WITH CONSTRUCTION. FAILURE TO DO SO, WILL VOID APPLICATION FOR CHANGE CONDITIONS.



TERRACOSTA CONSULTING GROUP, INC.
ENGINEERS & GEOLOGISTS
3890 MURPHY CANYON ROAD, SUITE 200
SAN DIEGO, CALIFORNIA 92123
(858) 573-6900



TerraCosta
Consulting Group

CALIFORNIA STATE LANDS COMMISSION

SEE SHEET C-6

IF DRAWING IS NOT FULL SIZE (24X36)
THEN REDUCE SCALE ACCORDINGLY




ORIGINAL SCALE IN INCHES FOR REDUCED PLANS



DATE _____ APPROVED _____

RD

NO.

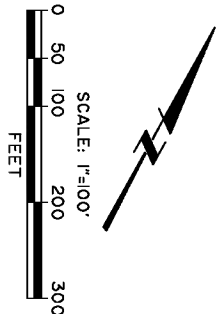

SEE SHEET C-5

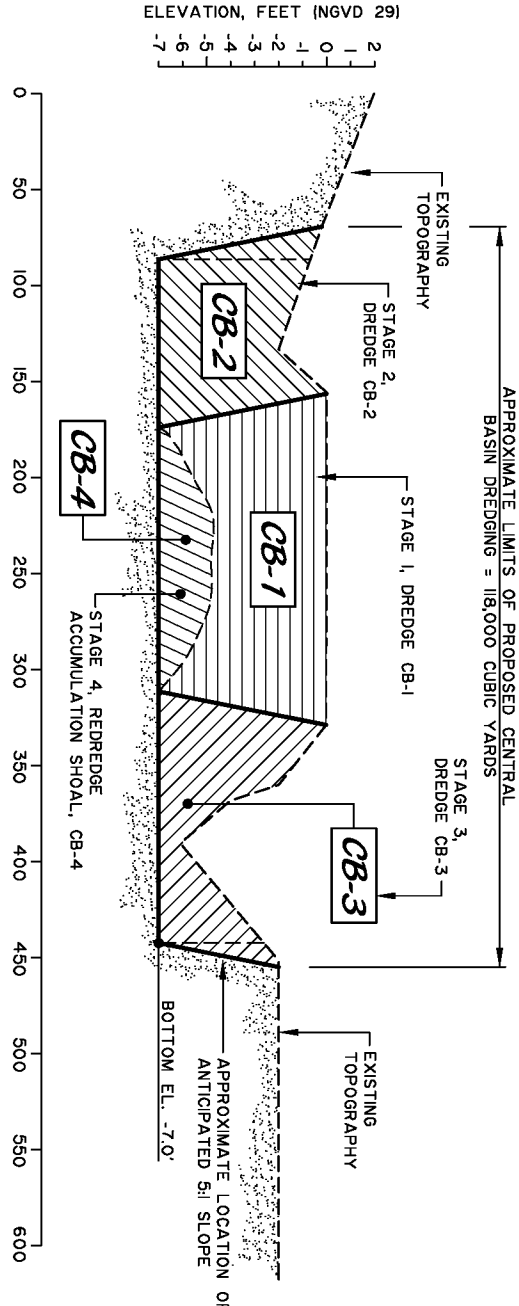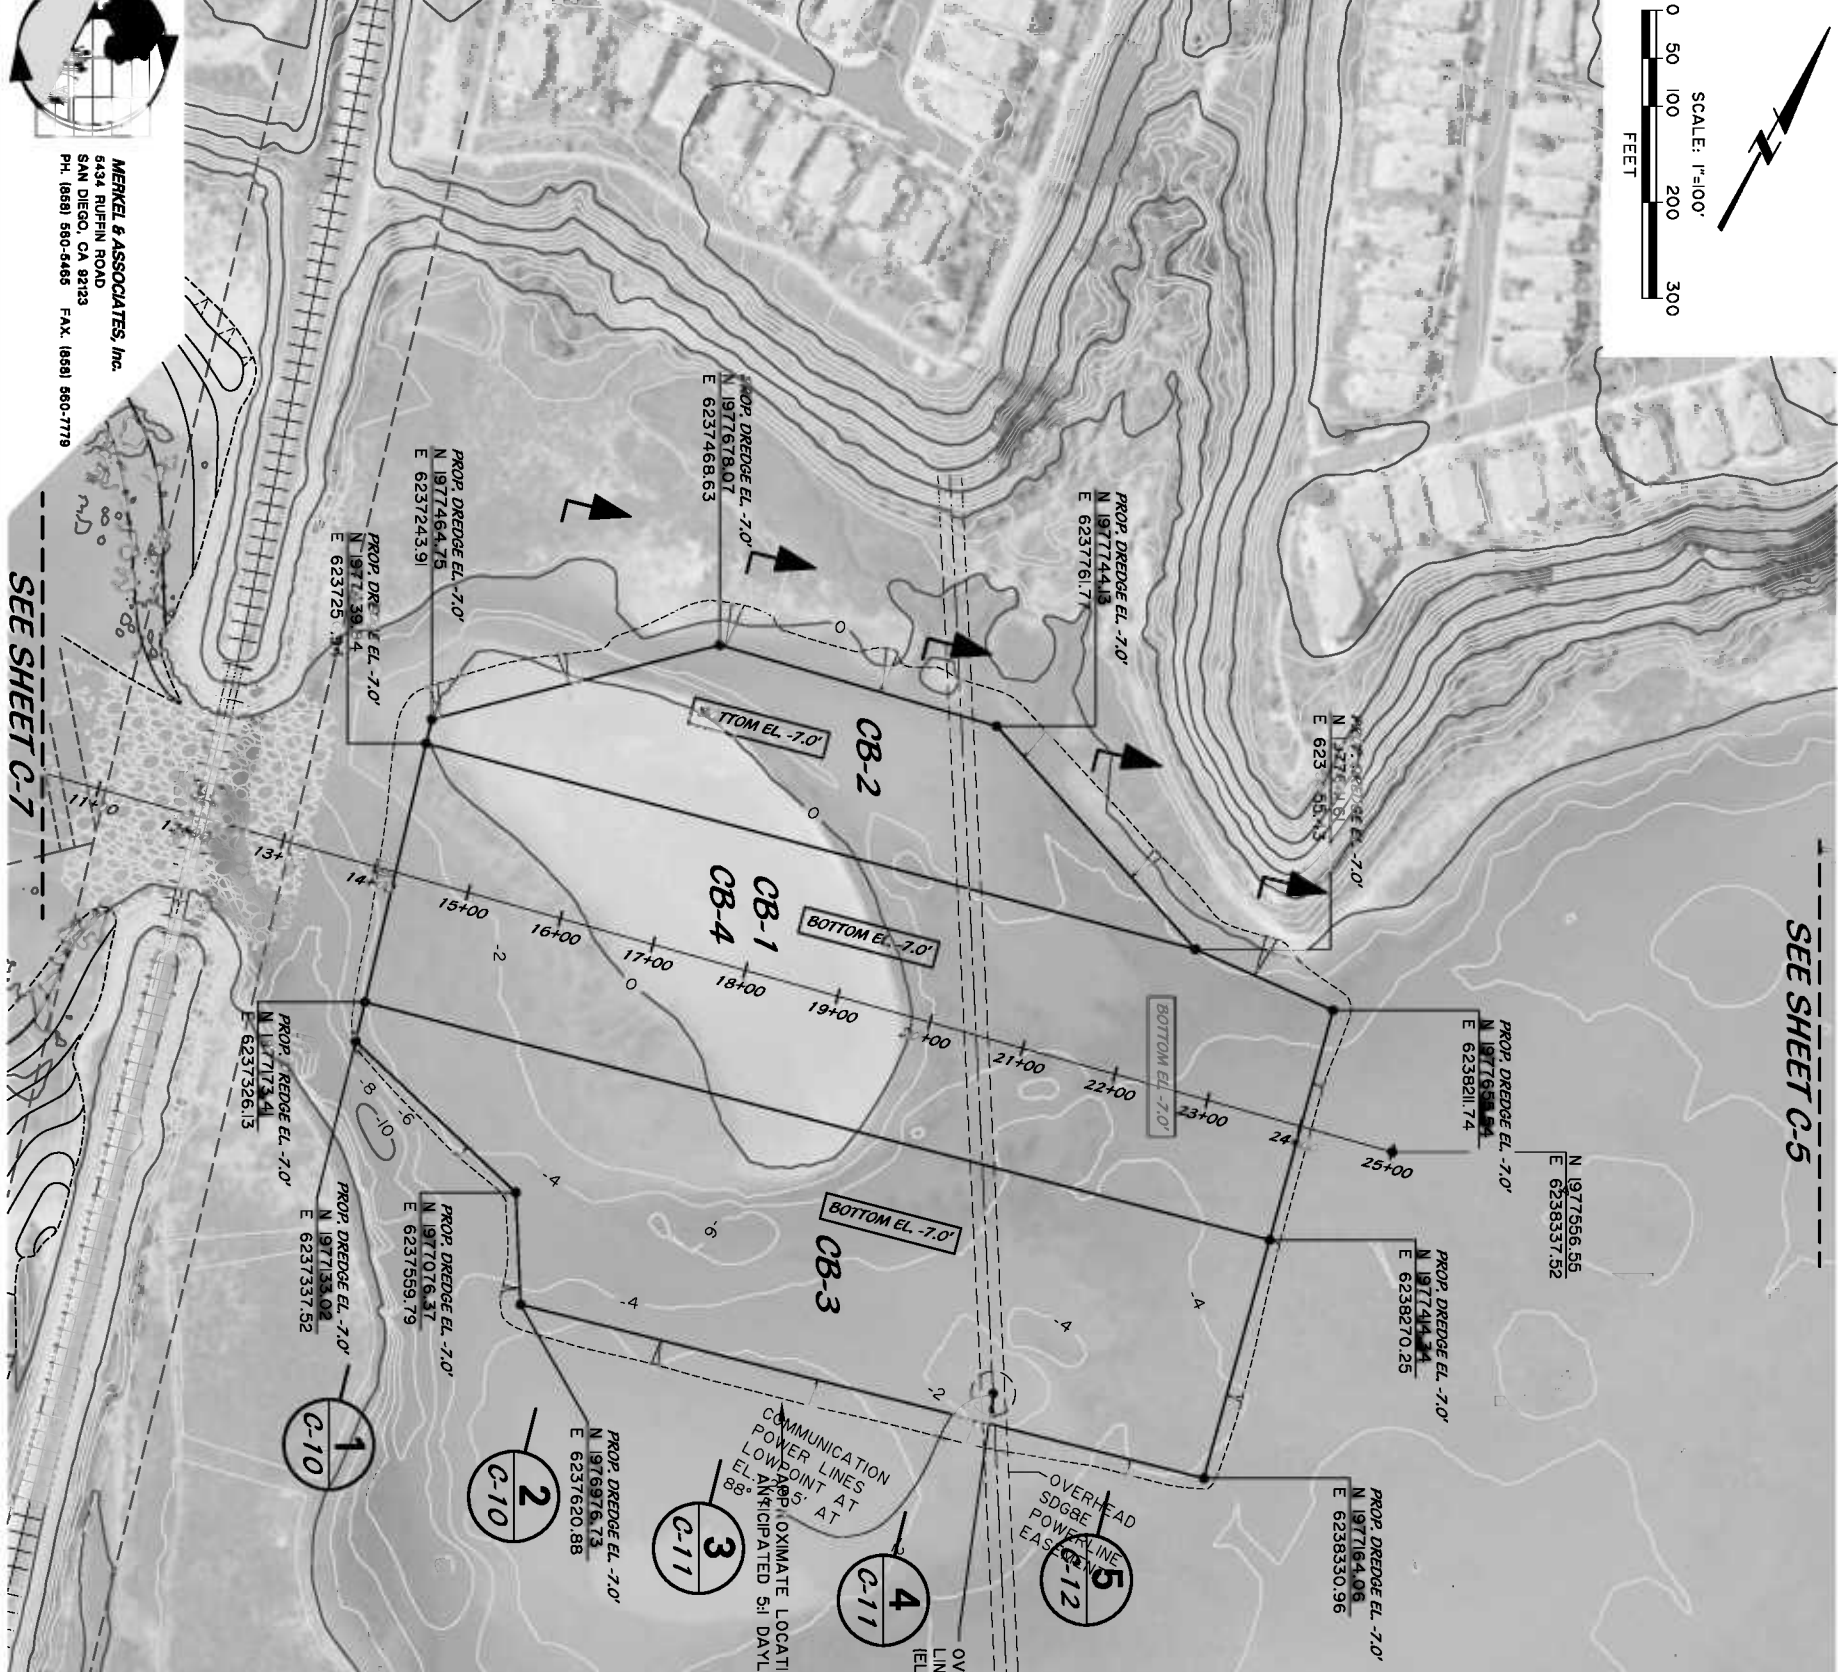

GENERALIZED CROSS SECTION

SCALE: 1"=50' (HORIZ.)
1"=4' (VERT.)

DREDGING STAGING NOTES

- DREDGING IS INTENDED TO BE STAGED IN A MANNER THAT ALLOWS FOR PARTIAL REMOVAL OF SEDIMENT'S PRESENTLY ACCUMULATED IN THE WEST BASIN THROUGH INCREASING FLOW EFFICIENCY IN THE CENTRAL BASIN AND STIMULATING SAND MOVEMENT FROM THE WEST BASIN CHANNEL TO THE OCEAN AND CENTRAL BASIN DREDGING BASIN. A PARTIAL REDREDGE OF THE CENTRAL BASIN SHOAL DREDGE ZONES AT THE END OF MAINTENANCE REMOVALS WOULD BE PERFORMED TO REMOVE ADDITIONAL ACCUMULATED SEDIMENT.
- DREDGING STAGES SHALL BE AS FOLLOWS:
 - DREDGE ZONE CB-1 EAST TO WEST TO OPEN A DIRECT FLOW PATHWAY.
 - DREDGE ZONE CB-2.
 - DREDGE ZONE CB-3.
 - REDREDGE ACCUMULATED SHOALING ZONE CB-4.
- SURVEYS FOR PAY QUANTITY CALCULATION SHALL BE CONDUCTED BETWEEN DREDGING OF EACH DREDGE ZONE. REDREDGE VOLUME OF CB-4 SHALL BE PAID AS VOLUME REMOVED ABOVE INITIAL DREDGING FLOOR OF CB-1 TO CB-3.
- NO DREDGING SHALL BE CONDUCTED OUTSIDE OF DREDGE ZONES, HOWEVER CONTRACTOR MAY BE PAID FOR SLOPE LAYBACK VOLUME UP TO 5:1 SLOPE ANGLE PRISM.

DIAL TOLL FREE
1-800-422-4133
AT LEAST TWO DAYS BEFORE YOU DIG

DIGSAFE

UNDERGROUND SERVICE ALERT OF SOUTHERN CALIFORNIA

NOTE:
CONTRACTOR IS ADVISED THAT THIS PROJECT INVOLVES WORK IN A FLUCTUATING MARINE TIDAL ENVIRONMENT ON SOFT MARINE SEDIMENT WITH AN UNSTABLE BASE. CONTRACTOR SHALL TAKE DUE PRECAUTIONS AND CARE IN ANTICIPATING PROBLEMS THAT MAY ARISE THEREFROM. ALL WORK SHALL BE IN CONFORMANCE WITH ALL REGULATORY AGENCY PERMITS, ENVIRONMENTAL CONDITIONS AND SPECIFICATIONS CONTAINED HEREIN.

THE DRAWINGS INCORPORATED HEREIN HAVE BEEN PREPARED, IN PART, BASED UPON INFORMATION FURNISHED BY OTHERS. THE DESIGN PROFESSIONAL CANNOT ASSURE ITS ACCURACY AND, THUS, IS NOT RESPONSIBLE FOR THE ACCURACY OF THESE DRAWINGS. CONTRACTOR SHALL BE RESPONSIBLE FOR OBTAINING ALL NECESSARY PERMITS AND ADVISED TO OBTAIN INDEPENDENT VERIFICATION OF ITS ACCURACY BEFORE APPLYING IT FOR ANY PURPOSE. IN ADDITION, DISCOVERY OF ANY DISCREPANCIES SHALL BE REPORTED WITHIN 24 HOURS OF DISCOVERY (BEFORE OR AFTER CONTRACT AWARD) TO THE GOVERNING AGENCY AND THE DESIGN ENGINEER FOR EVALUATION/DETERMINATION OF AN APPROPRIATE COURSE OF ACTION BEFORE PROCEEDING WITH CONSTRUCTION. FAILURE TO DO SO, WILL VOID APPLICATION FOR CHANGE CONDITIONS.

TerraCosta
Consulting Group

TERRACOSTA CONSULTING GROUP, INC.
ENGINEERS & GEOLOGISTS
3880 MURPHY CANYON ROAD, SUITE 200
SAN DIEGO, CALIFORNIA 92123
(619) 573-8900

REGISTERED PROFESSIONAL ENGINEER
No. 23792
Exp. 12/31/11
STATE OF CALIFORNIA
CIVIL

NO.	DESIGNED	DATE	APPROVED
	KM		
	DRAWN		
	GS		
	CHECKED		
	WFC		
BATIGUTOS LAGOON			
MAINTENANCE DREDGING 2011 - 2012			
SITE PLAN - CENTRAL BASIN			
C-6			




MERKEL & ASSOCIATES, Inc.
6434 RUFFIN ROAD
SAN DIEGO, CA 92133
PH. (619) 560-9465 FAX. (619) 560-7778

IF DRAWING IS NOT FULL SIZE (24X36)
THEN REDUCE SCALE ACCORDINGLY

0 1 2 3

ORIGINAL SCALE IN INCHES FOR REDUCED PLANS

CALIFORNIA STATE LANDS COMMISSION

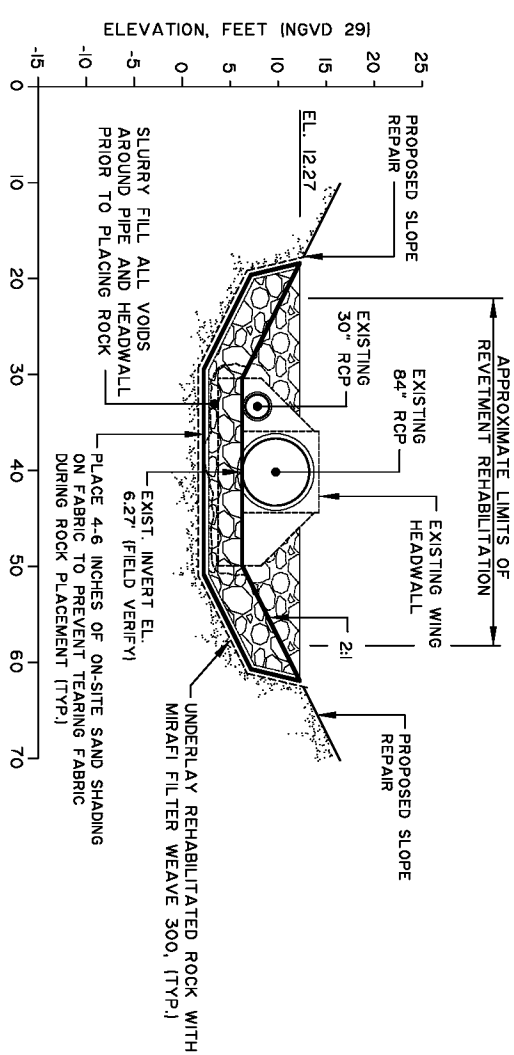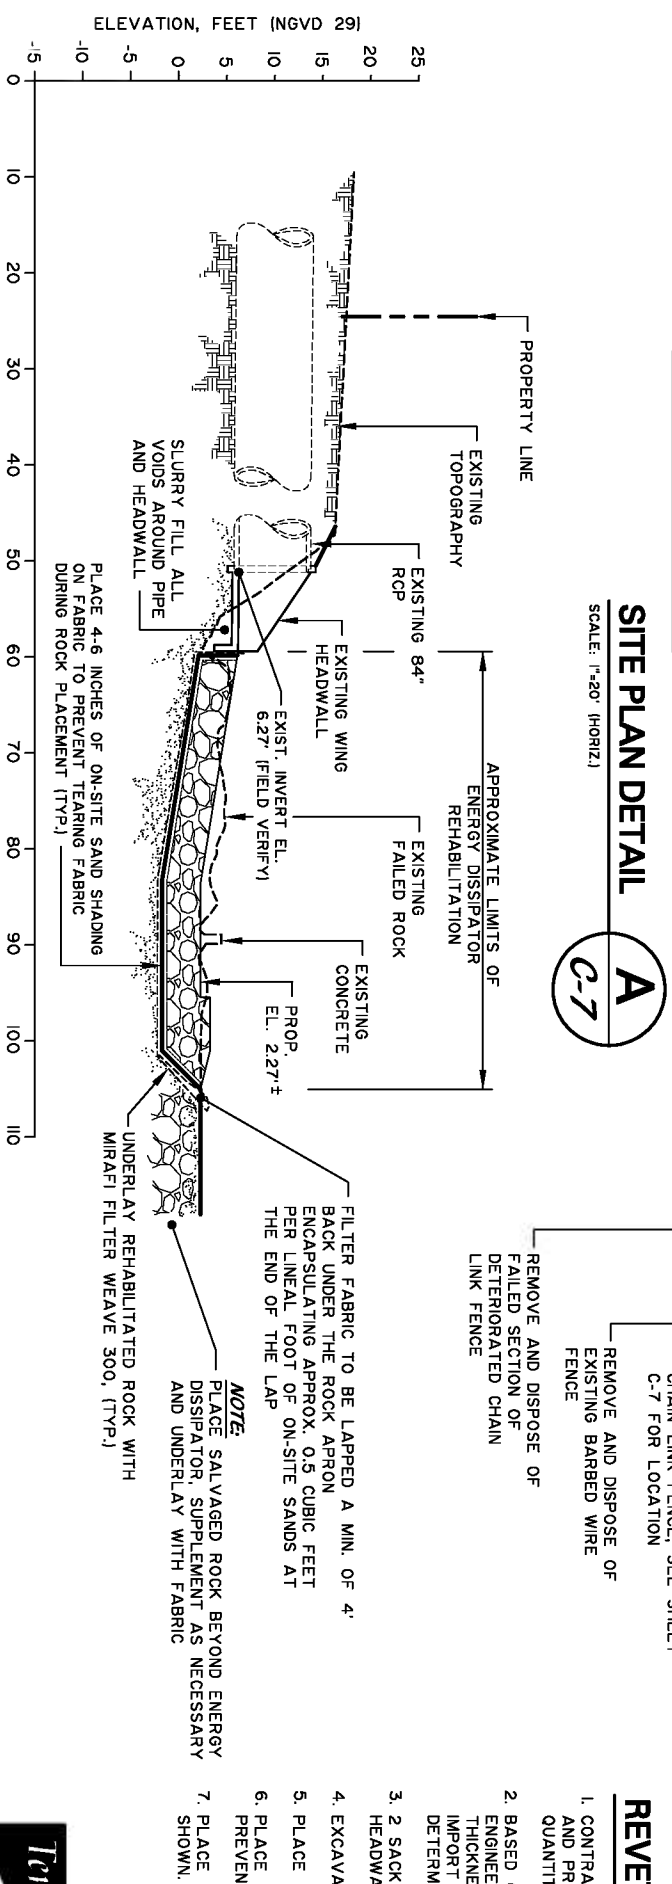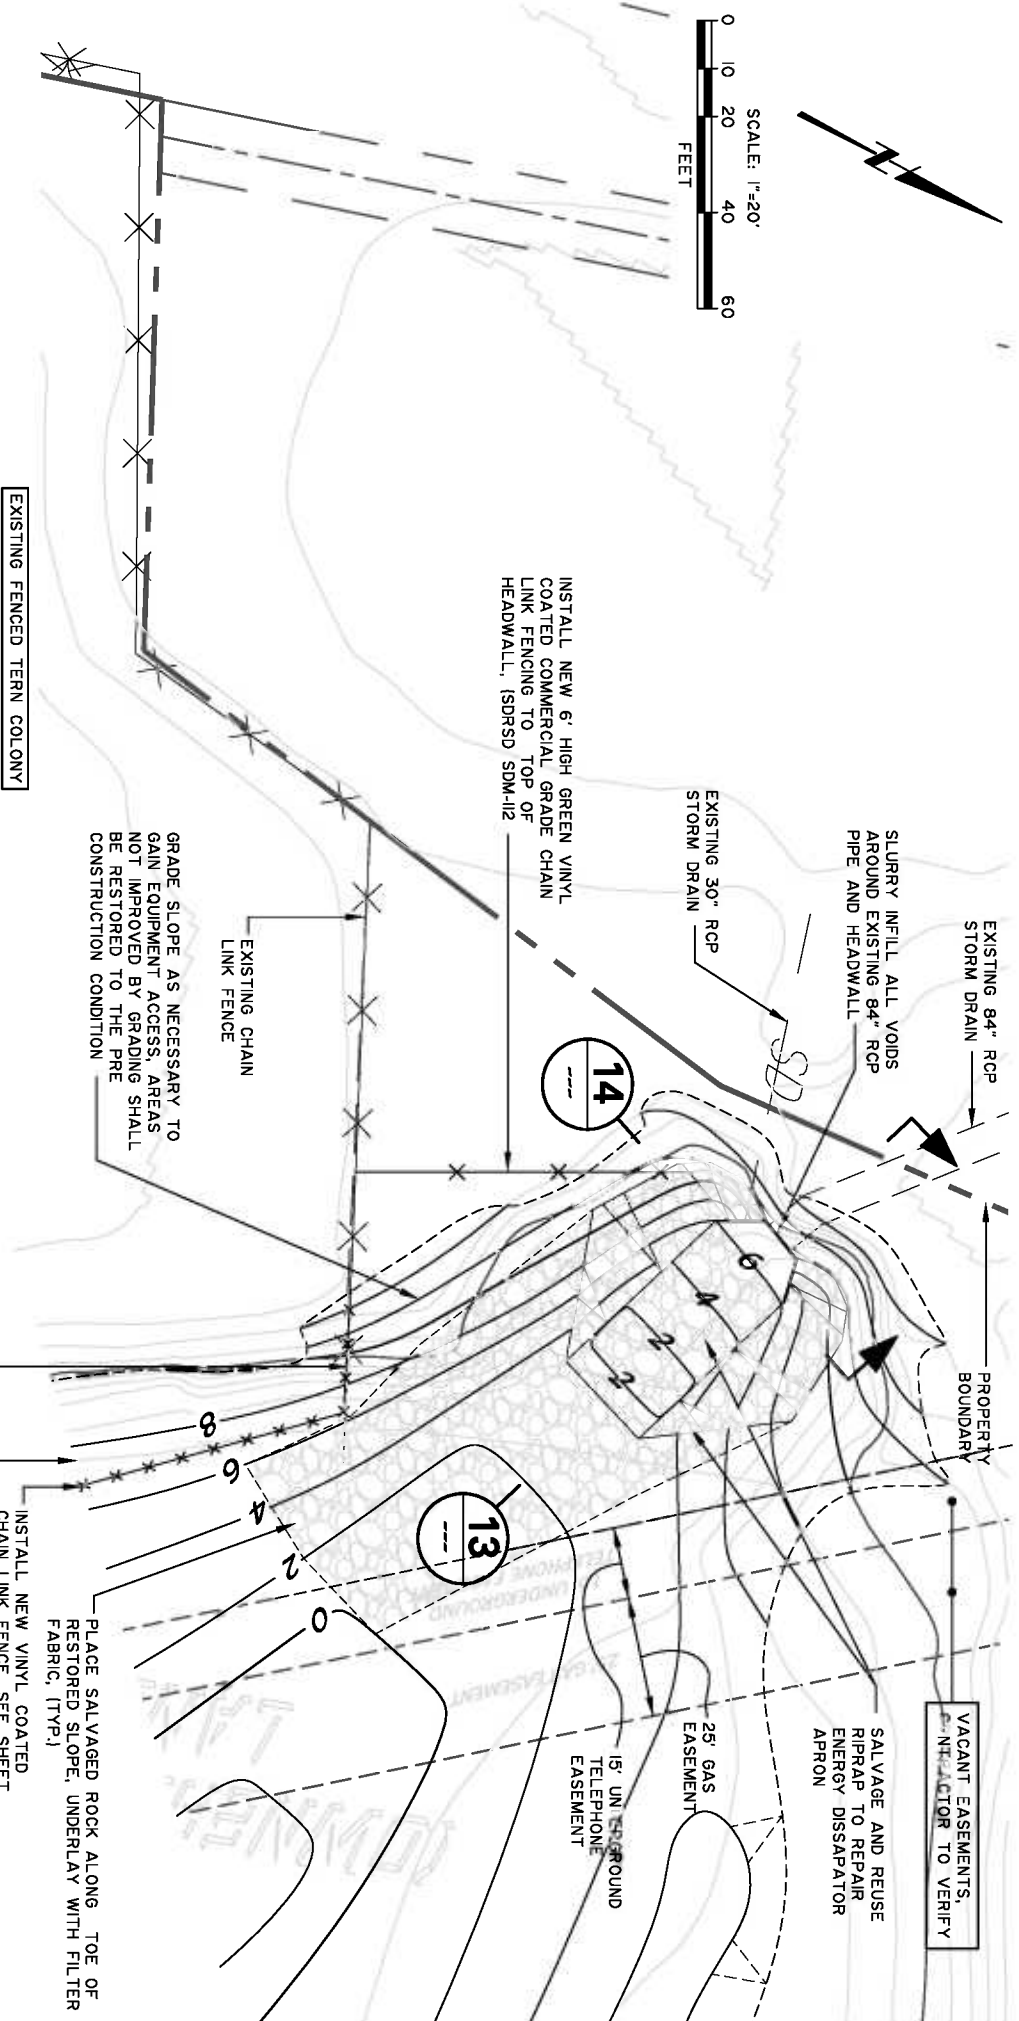

REVETMENT REPAIR SEQUENCE

1. CONTRACTOR SHALL SALVAGE AND STOCKPILE EXISTING ROCK AND PROVIDE ENGINEER OF RECORD AN ESTIMATE OF SIZE AND QUANTITY.
2. BASED ON CONTRACTOR ESTIMATES AND FIELD MEASUREMENTS, ENGINEER WILL EVALUATE SIZING AND THE REQUIRED LAY DOWN THICKNESS. IF REQUIRED, CONTRACTOR MAY BE REQUESTED TO IMPORT ADDITIONAL ROCK, (SIZE AND QUANTITY TO BE DETERMINED IN THE FIELD).
3. 2 SACK SLURRY FILL ALL VOIDS AROUND PIPE AND WING TYPE HEADWALL.
4. EXCAVATE AND FILL TO THE LINES AND GRADES INDICATED.
5. PLACE FILTER FABRIC FOR REHABILITATED ROCK SECTION.
6. PLACE 4 TO 6 INCHES OF ON-SITE SAND OVER FABRIC TO PREVENT TEARING DURING ROCK PLACEMENT.
7. PLACE SALVAGED ROCK, AND IMPORTED ROCK IF REQUIRED, AS SHOWN.



UNDERGROUND SERVICE ALERT OF SOUTHERN CALIFORNIA

OTE:

CONTRACTOR IS ADVISED THAT THIS PROJECT INVOLVES WORK IN A FLUCTUATING MARINE TIDAL ENVIRONMENT OF SOFT, MARINE SEDIMENT WITH AN UNSTABLE BASE. CONTRACTOR SHALL TAKE DUE PRECAUTIONS AND CARE ANTICIPATING PROBLEMS THAT MAY ARISE THEREFROM. WORK SHALL BE IN CONFORMANCE WITH ALL REGULATORY AGENCY PERMITS, ENVIRONMENTAL CONDITIONS AND SPECIFICATIONS CONTAINED HEREIN.

THE DRAWINGS INCORPORATED HEREIN HAVE BEEN PREPARED, IN PART, BASED UPON INFORMATION FURNISHED BY OTHERS. THE DESIGN PROFESSIONAL CANNOT ASSURE ITS ACCURACY, AND, THIS, IS NOT RESPONSIBLE FOR THE ACCURACY OF THESE DRAWINGS, OR FOR ANY ERRORS OR OMISSIONS WHICH MAY HAVE BEEN INCORPORATED INTO IT AS A RESULT. THOSE RELYING ON THESE DRAWINGS ARE ADVISED TO OBTAIN INDEPENDENT VERIFICATION OF ITS ACCURACY BEFORE APPLYING IT FOR ANY PURPOSE. IN ADDITION, DISCOVERY OF ANY DISCREPANCIES SHALL BE REPORTED WITHIN 24 HOURS OF DISCOVERY, (BEFORE OR AFTER CONTRACT AWARD) TO THE GOVERNING AGENCY AND THE DESIGN ENGINEER FOR EVALUATION/TERMINATION OF AN APPROPRIATE COURSE OF ACTION BEFORE PROCEEDING WITH CONSTRUCTION. FAILURE TO DO SO, WILL VOID APPLICATION FOR CHANGE CONDITIONS.


TERRACOSTA CONSULTING GROUP, INC.
ENGINEERS & GEOLOGISTS
3880 MURPHY CANYON ROAD, SUITE 200
SAN DIEGO, CALIFORNIA 92123
(658) 573-6900



TerraCosta
Consulting Group
DESIGN

CALIFORNIA STATE LANDS COMMISSION

IF DRAWING IS NOT FULL SIZE (24x36)
THEN REDUCE SCALE ACCORDINGLY



0 1 2 3

ORIGINAL SCALE IN INCHES FOR REDUCED PLANS

MERKEL & ASSOCIATES, Inc.
6434 RUFFIN ROAD
SAN DIEGO, CA 92123
PH. (858) 560-6466 FAX. (858) 560-7778

CROSS SECTION 13

SCALE: 1"=10' (HORIZ.)
1"=10' (VERT.)

CROSS SECTION 14

SCALE: 1"=10' (HORIZ.)
1"=10' (VERT.)

NO

REF

DATE / APPROVED

ORIGINAL SCALE IN INCHES FOR REDUCED PLANS



DESIGN		
DRAWN		
CHECK		

DRAWN	
CHECK	

1	2	3	100
---	---	---	---	---	---	---	---	---	----	----	-----

**BATQUITOS LAGOON
MAINTENANCE DREDGING 2011 - 2012
SITE PLAN - STORM DRAIN & REVETMENT RESTORATION**

DATE **8-25-11**
SHEET **9** OF **14**
DRAWING NO. **C-9**

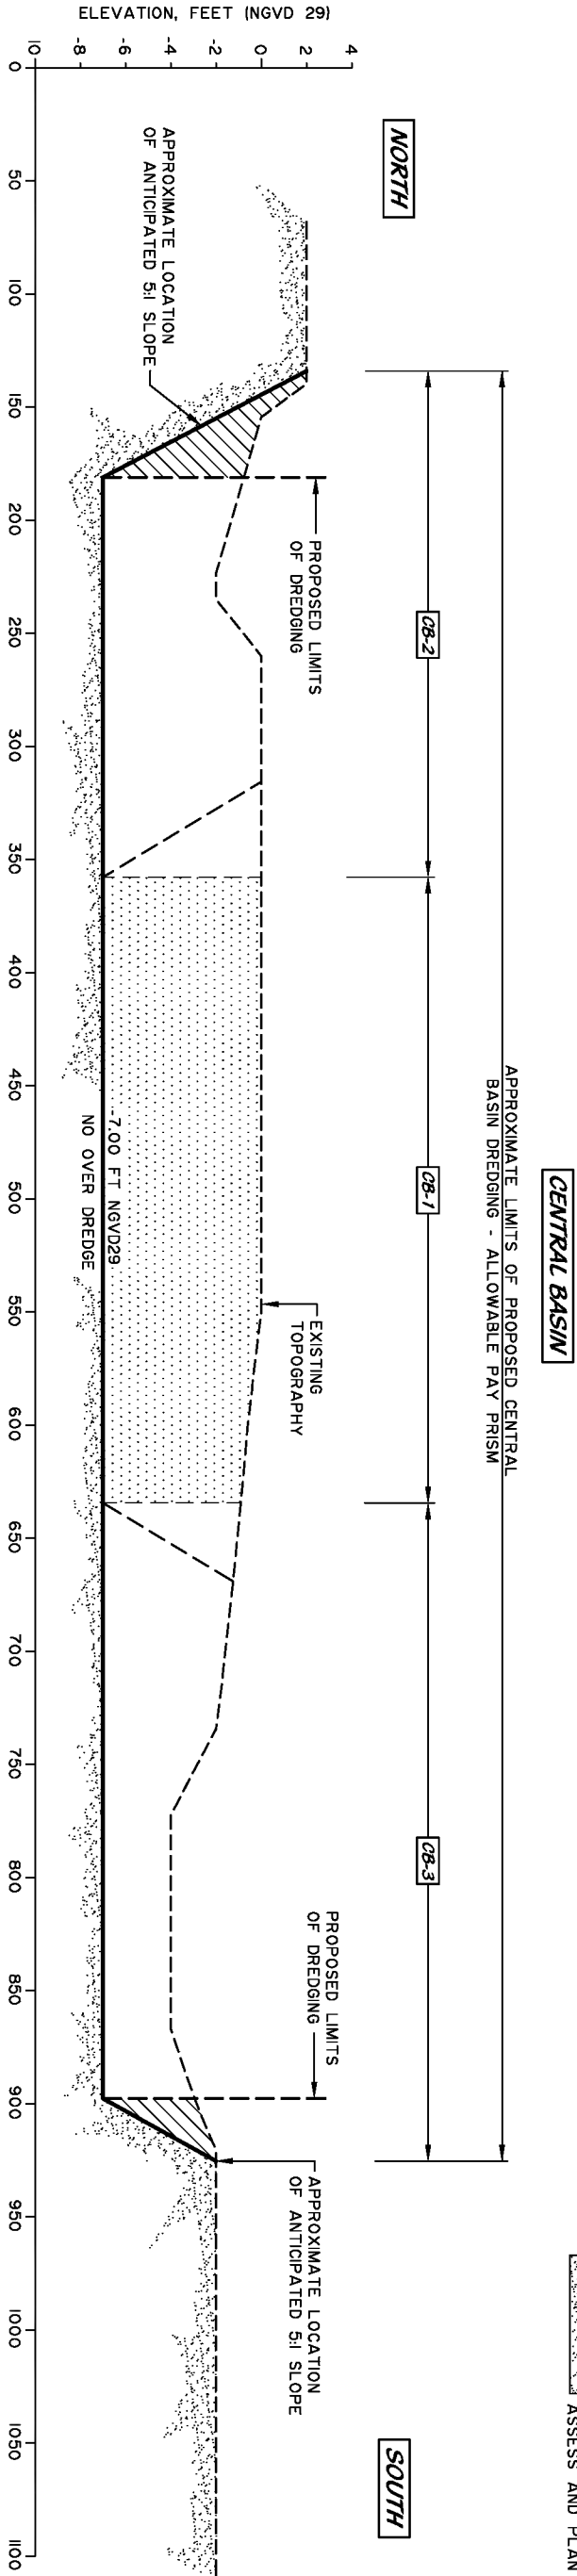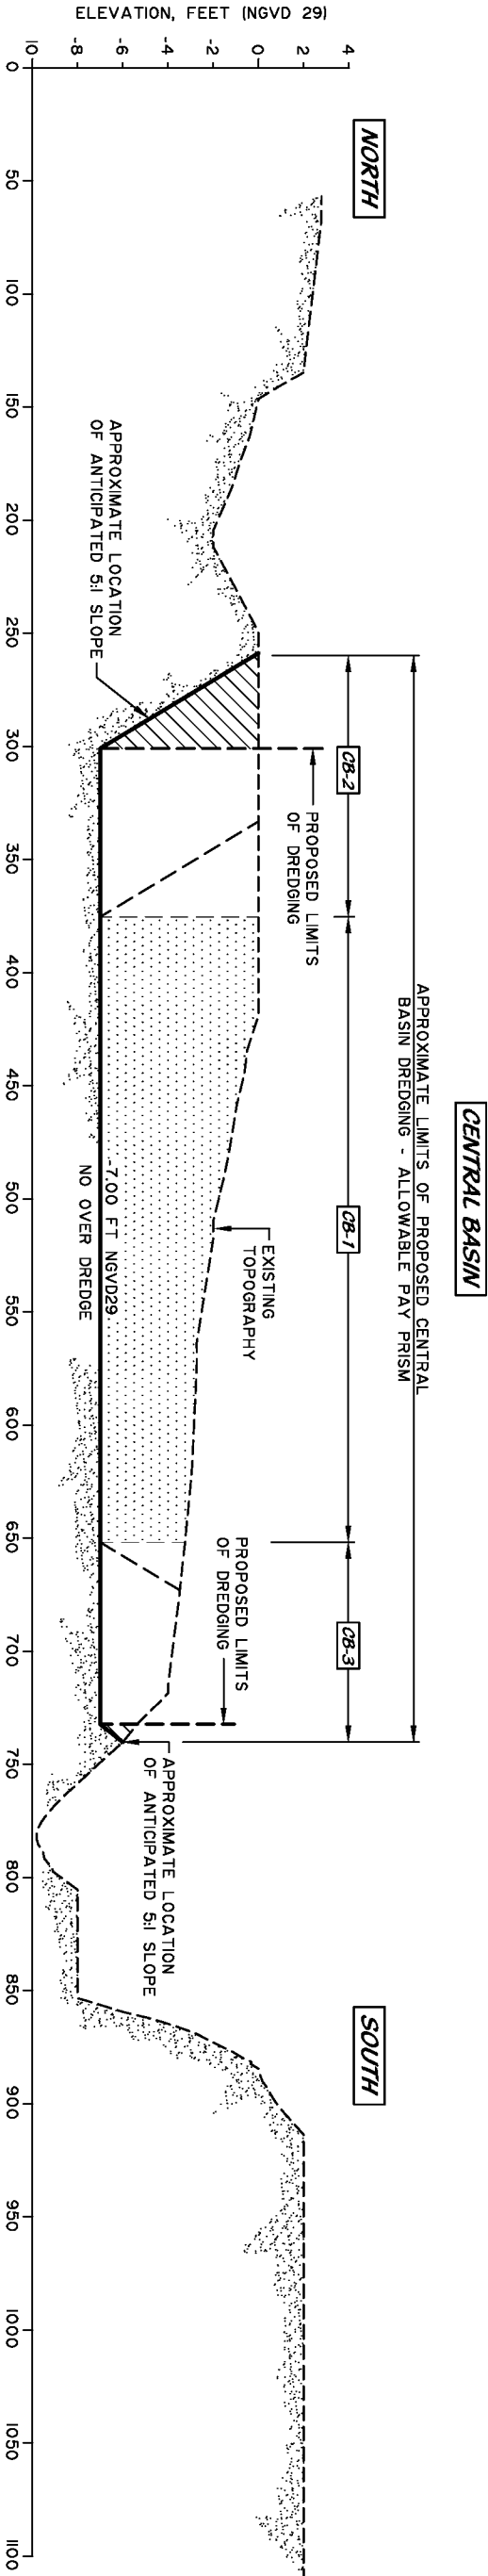

MERKEL & ASSOCIATES, Inc.
6434 RUFFIN ROAD
SAN DIEGO, CA 92123
PH. (658) 560-9465 FAX. (658) 560-7778

NO.	
DESIGNED	
DRAWN	
CHECKED	
DATE	APPROVED
IF DRAWING IS NOT FULL SIZE (24X36) THEN REDUCE SCALE ACCORDINGLY	
ORIGINAL SCALE IN INCHES FOR REDUCED PLANS	

CALIFORNIA STATE LANDS COMMISSION

DESIGNED	KM
DRAWN	GS
CHECKED	WFC

BATIGUITOS LAGOON
MAINTENANCE DREDGING 2011 - 2012

CROSS SECTIONS

C-10




TERRACOSTA CONSULTING GROUP, INC.
ENGINEERS & GEOLOGISTS
3890 MURPHY CANYON ROAD, SUITE 200
SAN DIEGO, CALIFORNIA 92123
(658) 573-8800



HOIST	TT	3/2/11	NAD	8
DATE	8-21-11			
SHEET	10	OF	14	
DRAWING NO.				
REV.				

CENTRAL BASIN

APPROXIMATE LIMITS OF PROPOSED CENTRAL BASIN DREDGING - ALLOWABLE PAY PRISM

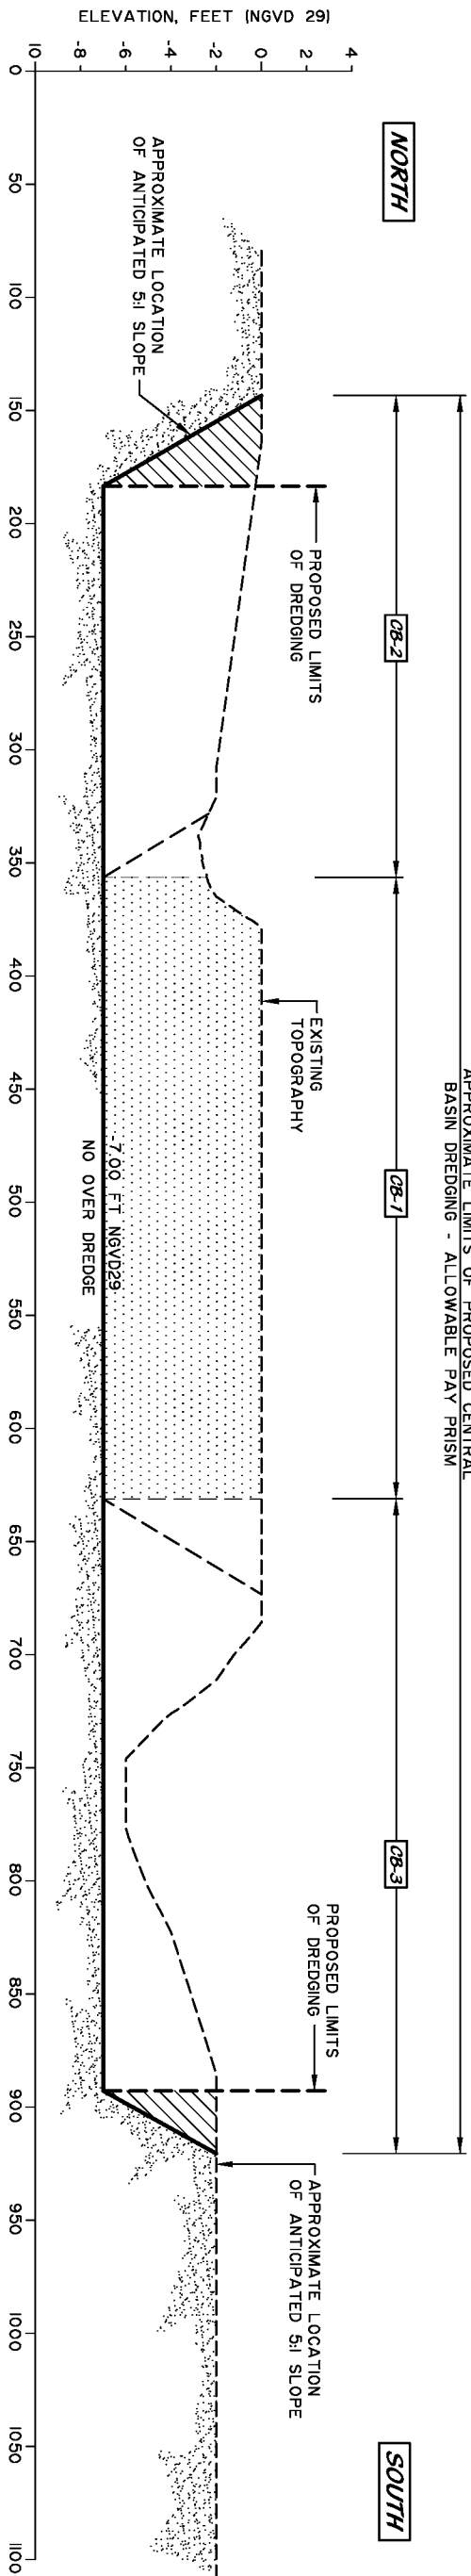


CROSS SECTION 3

SCALE: 1"=40' (HORIZ.)
1"=4' (VERT.)

CENTRAL BASIN LEGEND

- INDICATES APPROXIMATE LOCATION OF EXISTING TOPOGRAPHY
- INDICATES APPROXIMATE LOCATION OF PROPOSED FINISH GRADE
- INDICATES APPROXIMATE LIMITS OF PROPOSED CB-1 CUT
- HATCH INDICATES UNDIFFERENTIATED ON-SITE MATERIALS. CONTRACTOR TO ASSESS AND PLAN ACCORDINGLY

CENTRAL BASIN

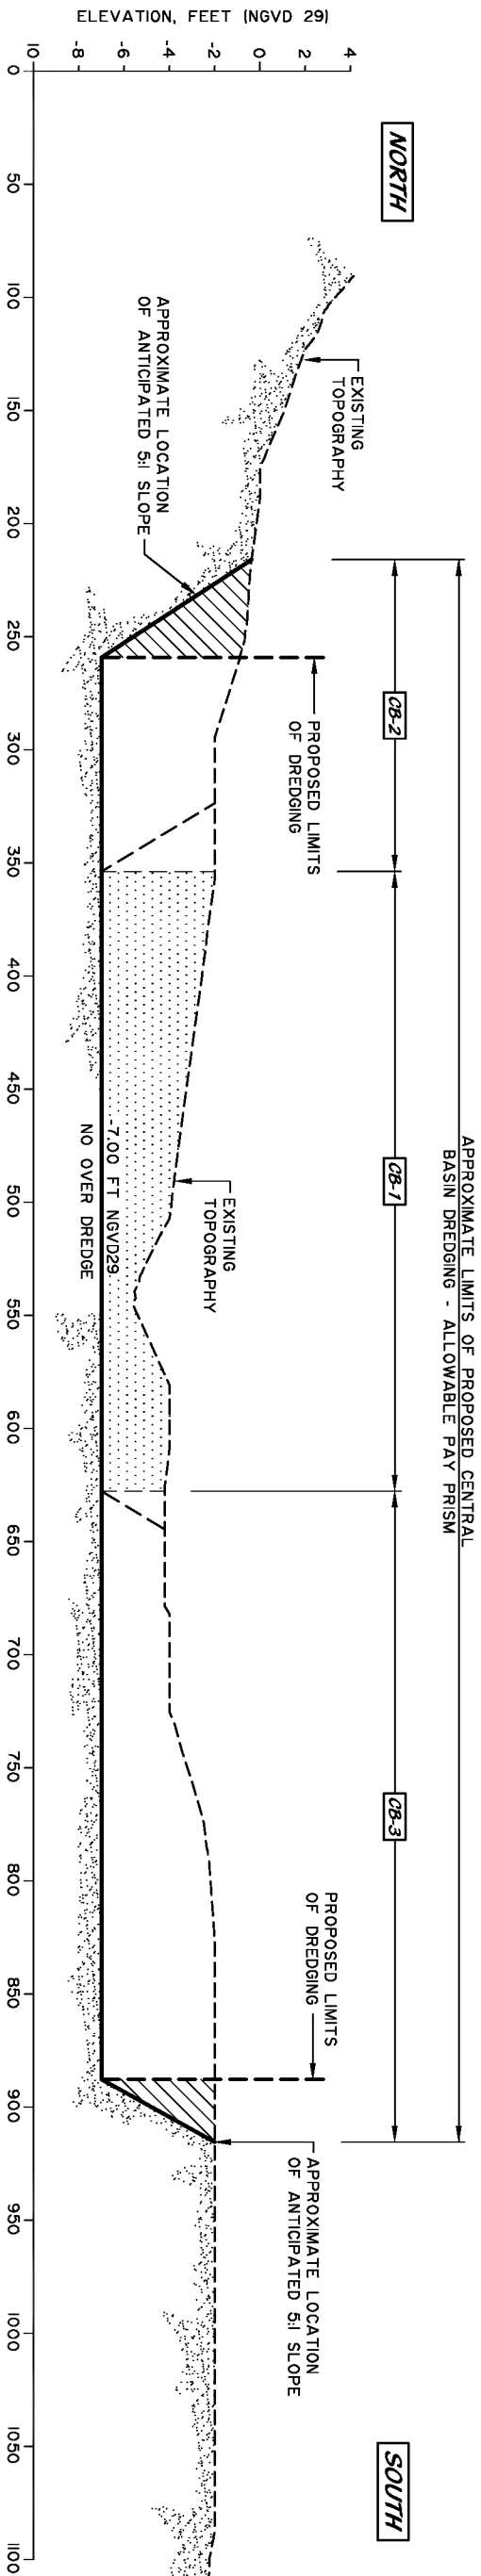

CROSS SECTION 4

SCALE: 1"=40' (HORIZ.)
1"=4' (VERT.)




MERKEL & ASSOCIATES, Inc.
6434 RUFFIN ROAD
SAN DIEGO, CA 92133
PH. (658) 560-9465 FAX. (658) 560-7778



TERRACOSTA CONSULTING GROUP, INC.
ENGINEERS & GEOLOGISTS
3890 MURPHY CANYON ROAD, SUITE 200
SAN DIEGO, CALIFORNIA 92123
(658) 573-8800




DESIGNED KM		DRAWN GS		CHECKED WFC	
DATE 8-28-11		SHEET 11 of 14		DRAWING NO. C-11	
NO.		DATE APPROVED		REV.	
IF DRAWING IS NOT FULL SIZE (24X36) THEN REDUCE SCALE ACCORDINGLY					
ORIGINAL SCALE IN INCHES FOR REDUCED PLANS					
CALIFORNIA STATE LANDS COMMISSION					
BATIGUITOS LAGOON MAINTENANCE DREDGING 2011 - 2012					
CROSS SECTIONS					

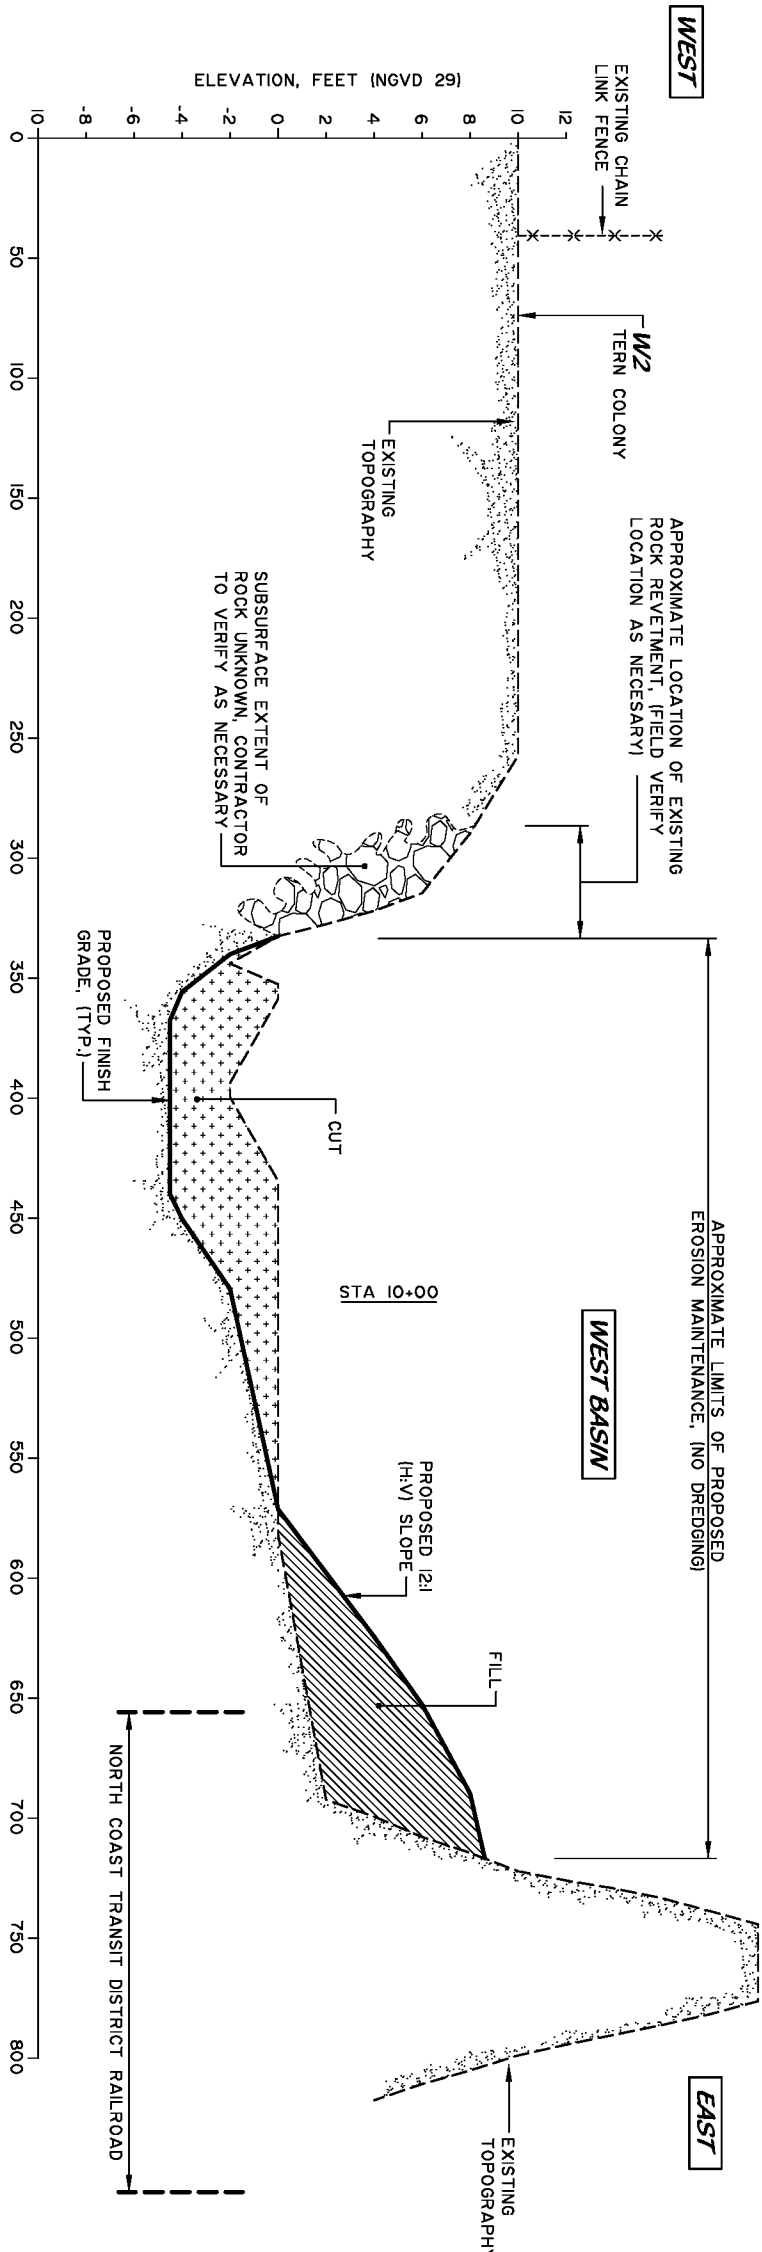


WEST BASIN LEGEND

- INDICATES APPROXIMATE LOCATION OF EXISTING TOPOGRAPHY
- INDICATES APPROXIMATE LOCATION OF PROPOSED FINISH GRADE
- INDICATES APPROXIMATE LIMITS OF PROPOSED CUT
- INDICATES APPROXIMATE LIMITS OF PROPOSED FILL
- HATCH INDICATES UNDIFFERENTIATED ON-SITE MATERIALS, CONTRACTOR TO ASSESS AND PLAN ACCORDINGLY

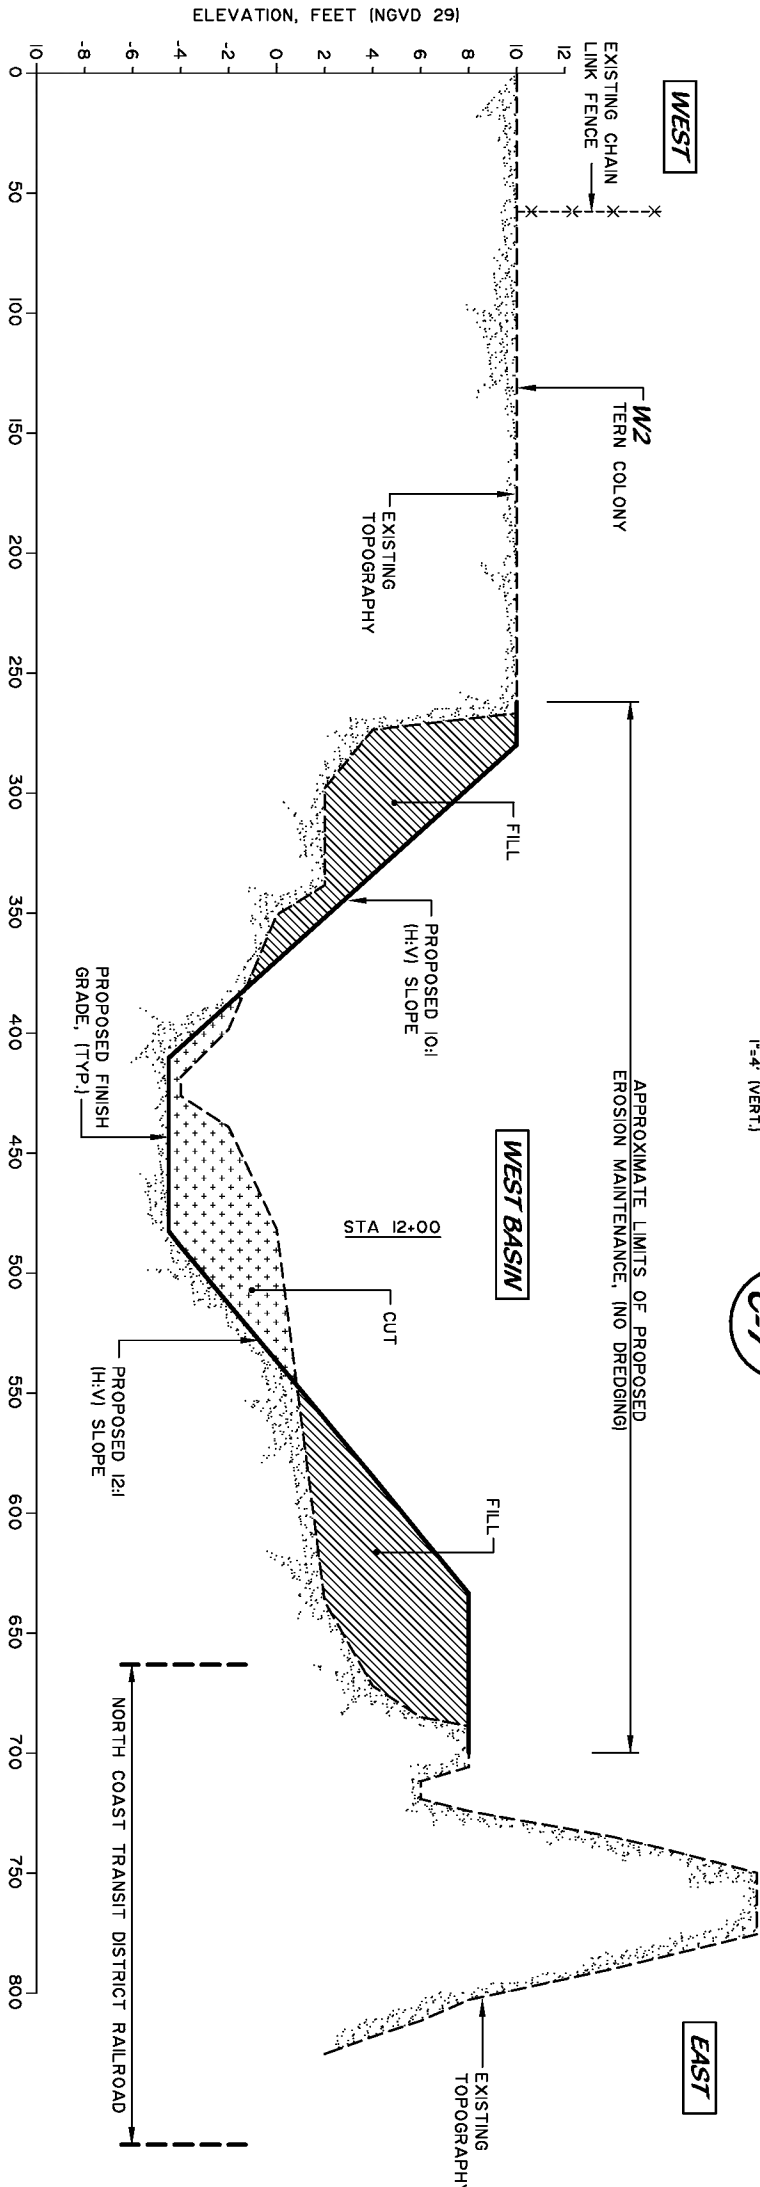

MERKEL & ASSOCIATES, Inc.
6434 RUFFIN ROAD
SAN DIEGO, CA 92133
PH. (658) 560-9465 FAX. (658) 560-7778







CROSS SECTION 8
SCALE: 1"=40' (HORIZ.)
1"=4' (VERT.)

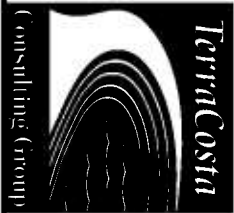


TERRACOSTA CONSULTING GROUP, INC.
ENGINEERS & GEOLOGISTS
3890 MURPHY CANYON ROAD, SUITE 200
SAN DIEGO, CALIFORNIA 92123
(658) 573-8800



NO.	DESIGNED	DATE	APPROVED	IF DRAWING IS NOT FULL SIZE (24X36) THEN REDUCE SCALE ACCORDINGLY	CALIFORNIA STATE LANDS COMMISSION	DATE	8-27-11
	DRAWN	GS		ORIGINAL SCALE IN INCHES FOR REDUCED PLANS		SHEET 13 OF 14	
	CHECKED	WFC				DRAWING NO. C-13	
CROSS SECTIONS						BATAQUITOS LAGOON MAINTENANCE DREDGING 2011 - 2012	

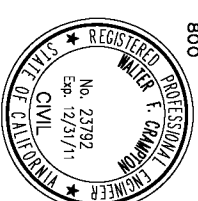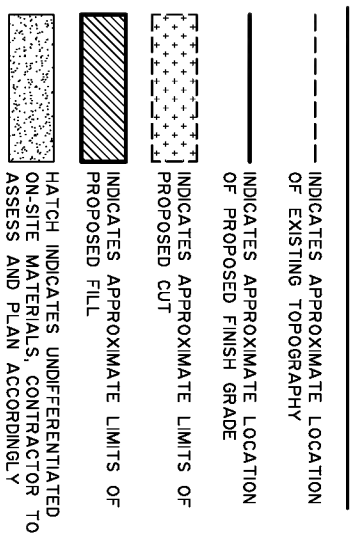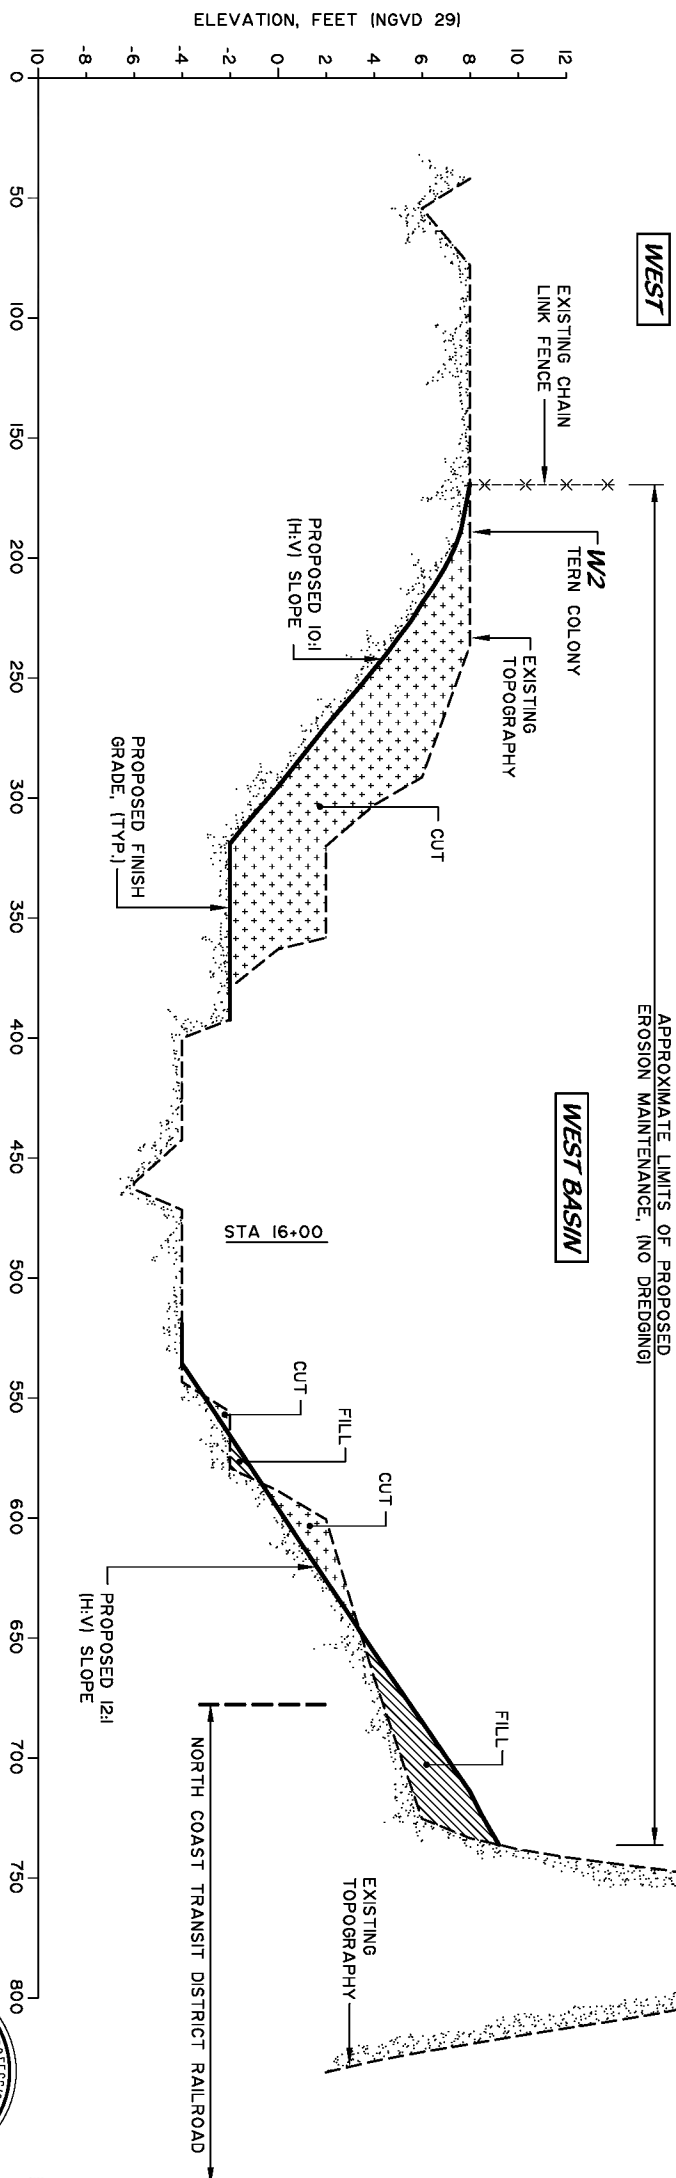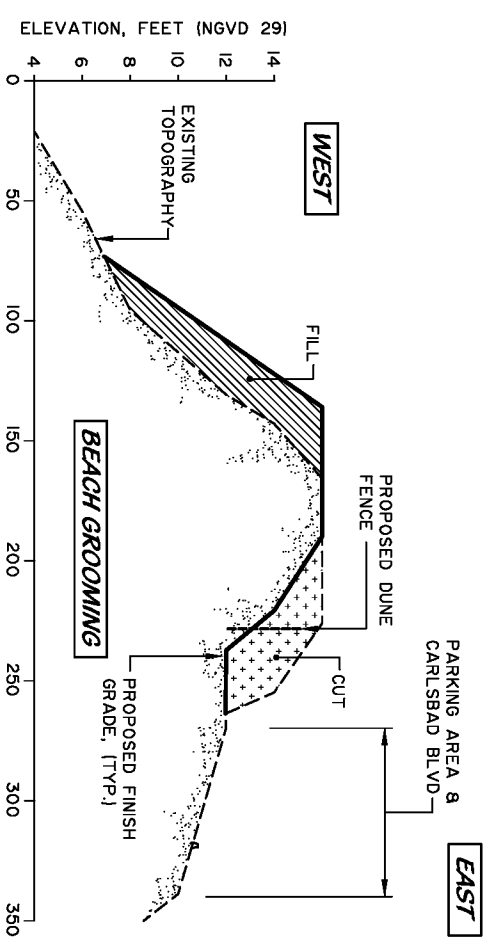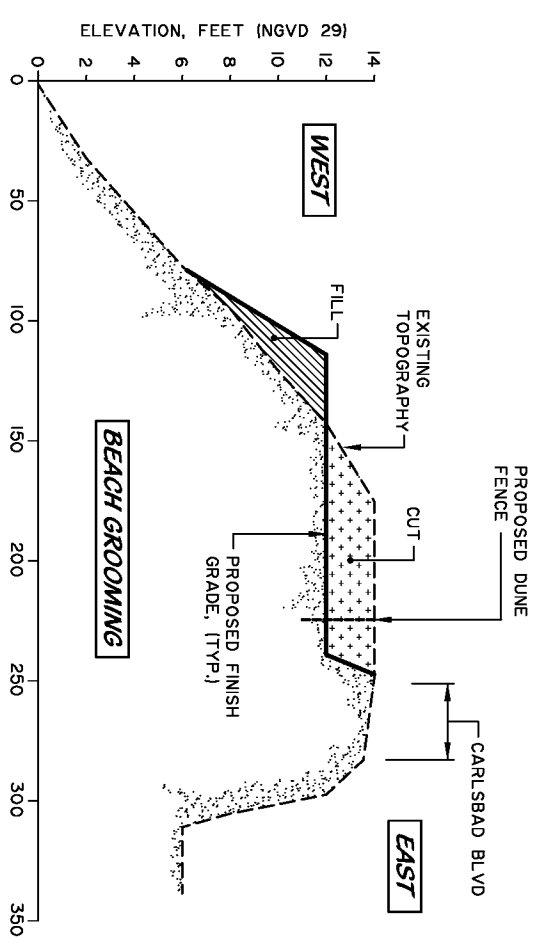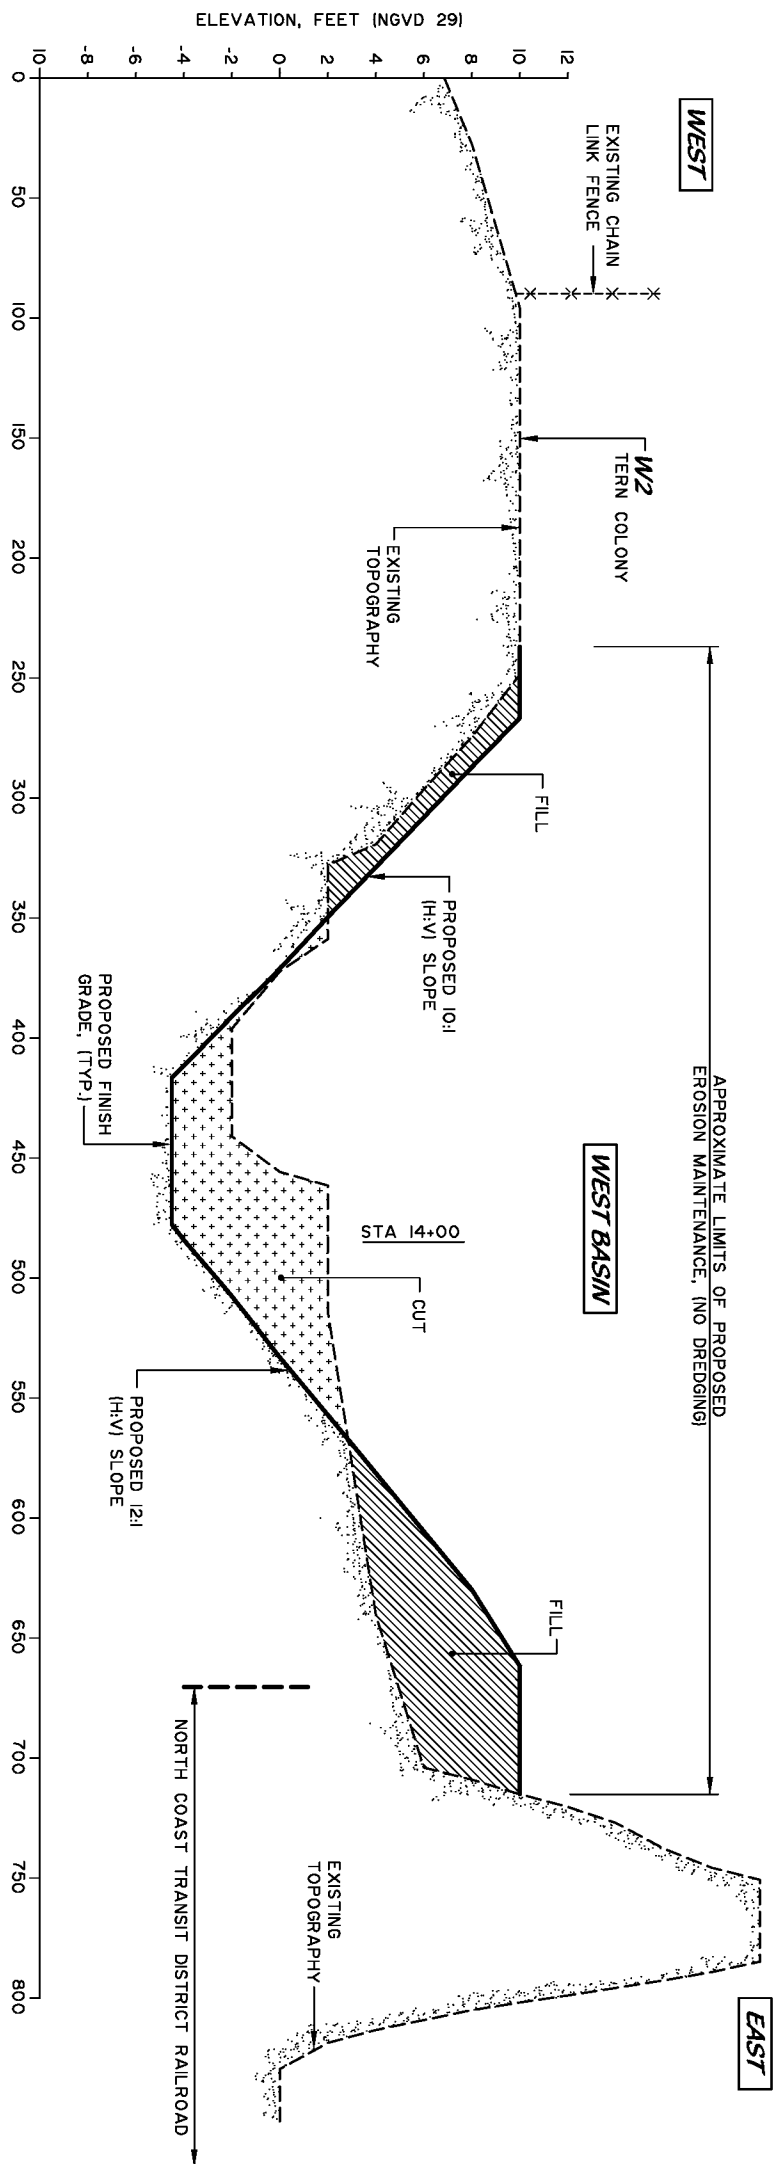[illegible]

IF DRAWING IS NOT FULL SIZE (24436)
THEN REDUCE SCALE ACCORDINGLY



0 1 2 3

ORIGINAL SCALE IN INCHES FOR REDUCED PLANS

CALIFORNIA STATE LANDS COMMISSION

DESIGNED	KM
DRAWN	GS
CHECKED	WFC

CARLSBAD, CALIFORNIA		HOBBS, STEVEN, NAD	
BATTUITOS LAGOON		DATE 8-28-11	
MAINTENANCE DREDGING 2011 - 2012		SHEET 14 OF 14	
CROSS SECTIONS		DRAWING NO. C-14	
		REV.	